

#### CHECKLIST FOR REQUIRED INSPECTION DEVEL OPER TYPE OF INSPECTION INSPECTION/ ENGINEER APPROVAL/DATE DATE I) PRECONSTRUCTION MEETINGS 2) COMPLETION OF SEDIMENT CONTROL MEASURES (IF USING BASIN SEE #6 BELOW) 3) PRIOR TO MODIFICATION OR REMOVAL OF SED. CNTRL. 4) INFILTRATION SYSTEMS A. SITE READINESS PER SEQUENCE OF CONSTRUCTION B. INFILTRATION AREA PROTECTED FROM SEDIMENTATION C. DIMENSIONS D. FILTERING MATERIAL (TYPE/DEPTH) E. FILL MATERIAL F. SIZE, PLACEMENT, TYPE OF PIPING (IF APPLICABLE) G. OBSERVATION WELL H. COVER / STABILIZATION 5) OPEN CHANNEL FLOW ATTENUATION A. SITE READINESS PER SEQUENCE OF CONSTRUCTION B. CROSS SECTION CONFORMANCE C. MATERIAL (TYPE/SIZE) D. STABILIZATION 6) RETENTION / DETENTION STRUCTURES (BASIN/PONDS) A. SUBGRADE PREPARATION I. CORE TRENCH 2. SUITABLE FILL 3. COMPACTION B. EMBANKMENT CONSTRUCTION I. SUITABLE MATERIAL 2. SLOPE GRADE C. BARREL AND RISER ASSEMBLY I. CORRECT MATERIAL ONSITE 2. SIZING 3. ANTI-SEEP COLLARS 4. INSTALLATION / BACKFILL D. CONCRETE INLET STRUCTURES I. FOOTER EXCAVATION AND SIZE 2. REINFORCING MATERIAL (TYPE, SIZE, PLACEMENT) 3. WEIR POUR

YOU MUST NOTIFY THE DIVISION OF ENVIRONMENTAL COMPLIANCE SECTION (ECS) AT (301) 600-3507 BEFORE 9:00 AM 24 HOURS PRIOR TO THE REQUIRED INSPECTION, FAILURE TO NOTIFY THE AGENCY WILL RESULT IN A STOP WORK ORDER OR OTHER PENALTIES AS OUTLINED IN FREDERICK COUNTY CODES. \*\*\*\* NOTICE \*\*\*\*

THIS LIST IS FOR SEQUENCE OF CONSTRUCTION ONLY, FREDERICK COUNTY ASSUMES NO RESPONSIBILITY OR LIABILITY FOR IMPROPER INSTALLATION OF ANY ITEM ON THIS CHECKLIST. THE AGENCY RECOMMENDS THAT A PROFESSIONAL ENGINEER BE PRESENT FOR EACH OF THE REQUIRED INSPECTIONS.

#### **Frederick County Soil Conservation District** Erosion and Sediment Control Plan Approval

Idamo H District Manager or Designee

8/25/2025

4. FORM STRIP AND FINISHING

I. LOW FLOW CHANNELS

2. DEWATERING DEVICE

3. EMERGENCY SPILLWAY

RIPRAP CHANNEL. ETC.)

G. VEGETATION STABILIZATION

F. OUTFALL AREA (LEVEL SPREADER.

E. IMPOUNDING AREA

H. MISCELLANEOUS

Plan is valid for 2 years from date of approval

SCD approval for erosion and sediment control is in accordance with the 2011 Maryland Standards and Specifications for Soil Erosion and Sediment Control and is contingent upon issuance of all applicable regulatory permits.

# EROSION AND SEDIMENT CONTROL - GENERAL NOTES

### SEDIMENT AND EROSION CONTROL NOTES

- I. ALL EROSION/SEDIMENT CONTROL MEASURES SHALL COMPLY WITH THE "MARYLAND STANDARDS AND SPECIFICATIONS FOR SOIL FROSION AND SEDIMENT CONTROL AS APPROVED BY THE COUNTY.
- 2. ALL DISTURBED AREAS NOT UNDER ACTIVE GRADING TO BE SEEDED WITHIN 7 DAYS OF INITIAL GRADING, FOR TEMPORARY SEEDING SPECIFICATIONS, SEE SECTION BI, "2011 MARYLAND STANDARDS AND SPECIFICATIONS FOR SOIL EROSION AND SEDIMENT CONTROL" PUBLISHED JOINTLY BY WATER MANAGEMENT ADMINISTRATION, SOIL CONSERVATION SERVICE AND STATE SOIL CONSERVATION
- 3. ALL EROSION AND SEDIMENT CONTROL MEASURES ARE TO BE IN PLACE PRIOR TO OR AT THE INITIATION OF GRADING.
- 4. ALL STORM DRAIN AND SANITARY SEWER LINES NOT IN PAVED AREAS AND NOT SUBJECT TO ACTIVE GRADING ARE TO BE MULCHED AND SEEDED WITHIN 7 DAYS OF INITIAL BACKFILL.
- 5. ELECTRIC POWER. TELEPHONE AND GAS LINES NOT IN ACTIVE GRADING AREAS ARE TO BE COMPACTED, SEEDED AND MULCHED WITHIN 7 DAYS AFTER INITIAL BACKFILL.
- 6. ALL EARTH BERMS AND SEDIMENT DAMS ARE TO BE MULCHED AND SEEDED (SEE SECTION B OF ABOVE REFERENCE) WITHIN 7 DAYS AFTER GRADING, ALL SOIL STOCKPILES ARE TO BE MULCHED AND SEEDED WITHIN 7 DAYS.
- 7. DURING CONSTRUCTION, ALL SEDIMENT CONTROL STRUCTURES WILL BE INSPECTED AFTER EACH RAINFALL AND REPAIRED IF NECESSARY, SEDIMENT TO BE REMOVED TO A SUITABLE DISPOSAL AREA AND STABILIZED WITH PERMANENT VEGATATIVE COVER. (SEE SECTION B OF "2011 MARYLAND STANDARDS AND SPECIFICATIONS FOR SOIL EROSION AND SEDIMENT CONTROL" PUBLISHED JOINTLY BY WATER MANAGEMENT ADMINISTRATION, SOIL CONSERVATION SERVICE AND STATE SOIL CONSERVATION COMMITTEE.)
- 8. CONTRACTOR IS RESPONSIBLE FOR MAINTAINING ALL SEDIMENT EROSION CONTROL MEASURES UNTIL DISTURBED AREAS ARE STABILIZED.
- 9. AFTER FINE GRADING, ALL DISTURBED AREAS ARE TO BE PERMANENTLY MULCHED AND SEEDED (SEE PERMANENT SEEDING & SOD NOTES).
- 10. NO SLOPE SHALL BE GREATER THAN 2:1.
- II. FOLLOWING INITIAL SOIL DISTURBANCE OR REDISTURBANCE, PERMANENT OR TEMPORARY STABILIZATION SHALL BE COMPLETED WITHIN THREE (3) CALENDAR DAYS AS TO THE AS TO THE SURFACE OF ALL PERIMETER CONTROLS, DIKES, SWALES, DITCHES, PERIMETER SLOPES, AND ALL SLOPES GREATER THAN 3 HORIZONTAL TO I VERTICAL (3:1): AND SEVEN (7) DAYS AS TO ALL OTHER DISTURBED OR GRADED AREAS ON THE PROJECT SITE. THIS DOES NOT APPLY TO THOSE AREAS WHICH ARE SHOWN ON THE PLAN AND ARE CURRENTLY BEING USED FOR MATERIAL STORAGE OR FOR THOSE AREAS ON WHICH ACTUAL CONSTRUCTION ACTIVITIES ARE CURRENTLY BEING PERFORMED. MAINTENANCE SHALL BE PERFORMED AS NECESSARY TO ENSURE THAT STABILIZED AREAS CONTINUOUSLY MEET THE APPROPRIATE REQUIREMENTS OF THE "2011 MARYLAND STANDARDS AND SPECIFICATIONS FOR SOIL EROSION AND SEDIMENT CONTROL".
- 12. ALL ERSOSION AND SEDIMENT CONTROL MEASURES SHALL BE INSTALLED AND MAINTAINED IN CONTINUOUS COMPLIANCE WITH THE LATEST VERSION OF THE MARYLAND STANDARDS AND SPECIFICATIONS FOR SOIL EROSION AND SEDIMENT CONTROL.
- 13. ALL UTILITIES, SUCH AS: STORM DRAIN, PUBLIC WATER, SANITARY SEWER, ELECTRIC POWER, FELEPHONE, CABLE AND GAS LINES, THAT ARE NOT IN PAVED AREAS AND ARE NOT UNDERGOING ACTIVE GRADING SHALL BE TEMPORARILY OR PERMANENTLY STABILIZED WITHIN 3 DAYS OF INITIAL DISTURBANCE.
- 14. THE OWNER DEVELOPER OR THEIR DESIGNATE IS RESPONSIBLE FOR CONDUCTING ROUTINE MAINTENANCE. THE SITE AND CONTROLS SHOULD BE INSPECTED WEEKLY AND THE NEXT DAY AFTER EACH RAIN\*\*. ANY ACCUMULATED SEDIMENT SHALL BE REMOVED AND DISPOSED OF IN A SUITABLE AREA AND SHALL BE TEMPORARILY OR PERMANENTLY STABILIZED.
- \*\* ANY PROJECT THAT HAS A STATE ISSUED N.O.I. PERMIT MUST DOCUMENT EACH INSPECTION AND MAINTAIN AN INSPECTION LOG (PLEASE SEE N.O.I. FOR DETAILS).

## **ENGINEER'S DESIGN CERTIFICATION:**

I hereby certify this plan has been designed in accordance with local ordinances, COMAR 26.17.01, and 2011 Maryland Standards and Specification for Soil Erosion and Sediment Control and is contingent upon issuance of all applicable regulatory permits. If applicable, this plan is also designed in accordance with the requirements contained within USDA, NRCS "Standards and Specifications for Ponds MD-378" and the policies and procedures of the Maryland Department of the Environment Dam Safety program.

57703 ENGINEER'S SIGNATURE P.E. NO. 06/27/2025 ANDREW K. RINELLA DATE PRINT NAME

#### OWNER / DEVELOPER'S CERTIFICATION:

I/We hereby certify that any clearing, grading, construction and/or development will be done pursuant to this plan and that any responsible personnel involved in this construction project will have a Certificate of Attendance at a Maryland Department of the Environment approved training program for the control of sediment and erosion before beginning the project. I/We also certify that the site will be inspected at the end of each working day, and that any needed maintenance will be completed so as to ensure that all sediment control practices are left in operational condition. I/We authorize the right of entry for periodic onsite evaluation by the Frederick County Soil Gonservation District Board or their authorized agents.

SIGNATURE OWNER/DEVELOPER

06/27/2025

RALPH MOBLEY, JR. PRINT NAME

PROJECT MANAGER TITLE

## PERMANENT SEEDING & SOD NOTES

#### GENERAL

- I. SCOPE: PLANTING PERMANENT, LONG-LIVED VEGETATIVE COVER ON GRADED OR CLEARED AREAS.
- 2. STANDARDS: PERMANENT SEEDING SHALL CONFORM TO ALL REQUIREMENTS OF "2011 MARYLAND" STANDARDS AND SPECIFICATIONS FOR SOIL EROSION AND SEDIMENT CONTROL" PUBLISHED JOINTLY BY WATER RESOURCES ADMINISTRATION, SOIL CONSERVATION SERVICE, AND THE STATE SOIL CONSERVATION COMMITTEE.

#### SPECIFICATIONS

- I. SITE PREPARATION
- A) PRIOR TO SEEDING INSTALL ALL REQUIRED SEDIMENT AND EROSION CONTROL MEASURES.
- B) FINE GRADING REQUIRED FOR PERMANENT SEEDING.

#### SOIL AMENDMENTS

- A) FERTILIZER SHALL BE APPLIED AT THE RATE OF 1000 LBS./ACRE USING 10-10-10 OR EQUIVALENT.
- SEEDBED PREPARATION
- A) SOIL SHALL BE LOOSENED TO A DEPTH OF 3 INCHES BY RAKING, DISCING OR OTHER ACCEPTABLE MEANS PRIOR TO SEEDING.

#### 4. SEEDING

A) SELECT A MIXTURE FROM TABLE B.2 & B.3 IN STANDARD SPECIFICATIONS. B) APPLY SEED UNIFORMLY WITH A CYCLONE SEEDER, DRILL, CULTIPACKER SEEDER OR HYDROSEEDER (SLURRY INCLUDES SEED AND FERTILIZER ON A FIRM, MOIST SEEDBED). MAXIMUM SEEDING DEPTH SHOULD BE 1/4" ON CLAYEY SOILS AND 1/2" ON SANDY SOILS, WHEN USING OTHER THAN HYDROSEEDER METHOD OF APPLICATION, NOTE: IF HYDROSEEDING IS USED AND THE SEED AND FERTILIZER IS MIXED. THEY WILL BE MIXED ON SITE AND SEEDING SHALL BE IMMEDIATE WITHOUT INTERRUPTION.

#### PERMANENT STABILIZATION WITH SOD

- I. ALL SPECIFICATIONS, SITE PREPARATION, INSTALLATION AND MAINTENANCE OF SOD FOR PERMANENT, LONG-LIVED VEGETATIVE COVER SHALL CONFORM TO SECTION B OF "2011 MARYLAND STANDARDS AND SPECIFICATIONS FOR SOIL EROSION AND SEDIMENT CONTROL\* PUBLISHED JOINTLY BY WATER MANAGEMENT ADMINISTRATION, SOIL CONSERVATION SERVICE AND STATE SOIL CONSERVATION COMMITTEE.
- NOTE: ALL AREAS TO BE ROUGH GRADED AND/OR GRADED ONLY ARE TO BE STABILIZED BY PERMANENT SEEDING AND MULCHING WITHIN 7 DAYS AFTER GRADING IS COMPLETED. (SEE "TEMPORARY SEEDING NOTES").

#### FOR UTILITY WORK ONLY OR FOR OFF-SITE UTILITY WORK

- I. DISTURBANCE OUTSIDE OF LOD CAN NOT EXCEED 5000 SQUARE FEET.
- 2. PLACE ALL EXCAVATED MATERIAL ON THE HIGH SIDE OF THE TRENCH.
- 3. ONLY DO AS MUCH WORK AS CAN BE DONE IN ONE DAY SO BACKFILLING, FINAL GRADING. SEEDING AND MULCHING CAN OCCUR
- 4. ANY SEDIMENT CONTROL MEASURES DISTURBED BY CONSTRUCTION WILL BE REPAIRED THE

## STAGING/STOCKPILE AREAS

- I. STOCKPILE SIDE SLOPE RATIO CANNOT BE STEEPER THAN 2:1. BENCHING MUST BE PROVIDED IN ACCORDANCE WITH SECTION B-3 LAND GRADING IF REQUIRED.
- 2. IF STOCKPILE AREA NEEDS TO BE ENLARGED DURING CONSTRUCTION, SILT FENCE SHOWN MUST BE EXPANDED TO WRAP AROUND STOCKPILE AREA IN THE MANNER SHOWN ON PLAN
- 3. ACCESS THE STOCKPILE AREA FROM THE UPGRADE SIDE.
- 4. STOCKPILE MUST BE STABILIZED IN ACCORDANCE WITH THE 3/7 DAY STABILIZATION REQUIREMENT AS WELL AS STANDARD B-4-I INCREMENTAL STABILIZATION AND STANDARD B-4-4 TEMPORARY STABILIZATION.
- 5. THE STOCKPILE AREA MUST CONTINUOUSLY MEET THE REQUIREMENTS FOR ADEQUATE VEGETATIVE ESTABLISHMENT IN ACCORDANCE WITH SECTION B-4 VEGETATIVE STABILIZATION. SIDE SLOPES MUST BE MAINTAINED AT NO STEEPER THAN A 2:1 RATIO. THE STOCKPILE AREA MUST BE KEPT FREE OF EROSION. IF VERTICAL HEIGHT OF A STOCKPILE EXCEEDS 20 FEET FOR 2:1 SLOPES, 30 FEET FOR 3:1 SLOPES, OR 40 FEET FOR 4:1 SLOPES, BENCHING MUST BE PROVIDED IN ACCORDANCE WITH SECTION B-3 LAND GRADING.
- 6. NO STOCKPILING ALLOWED ON ASPHALT AND/OR GRAVEL ROADWAY
- 7. THE CONTRACTOR SHALL PROVIDE SEDIMENT CONTROL FOR THE STAGING / STOCKPILE AREA, AND THE COST FOR THE SEDIMENT CONTROL SHALL BE INCIDENTAL TO THE SEDIMENT CONTROLS SHOWN ON THE PLANS. THE CONTRACTOR SHALL CONTACT THE EROSION AND SEDIMENT CONTROL INSPECTOR FOR PROPER PLACEMENT OF THE STAGING / STOCKPILE AREA REGARDLESS OF WHETHER THE STAGING / STOCKPILE AREA IS WITHIN THE PROJECT SITE OR NOT.

## TEMPORARY SEEDING NOTES

#### **GENERAL**

- I. SCOPE: PLANTING SHORT TERM VEGETATION TO STABILIZED CLEARED OR GRADED AREA SUBJECT TO EROSION FOR A PERIOD OF 7 DAYS OR MORE.
- 2. STANDARDS: TEMPORARY SEEDING SHALL CONFORM TO ALL REQUIREMENTS OF "2011 MARYLAND" STANDARDS AND SPECIFICATIONS FOR SOIL EROSION AND SEDIMENT CONTROL" PUBLISHED JOINTLY BY WATER RESOURCES ADMINISTRATION, SOIL CONSERVATION SERVICE, AND THE STATE SOIL CONSERVATION COMMITTEE.
- 3. SEDIMENT AND EROSION CONTROL: ALL PERIIMETER CONTROLS MUST BE STABILIZED IN 3 DAYS: ALL INTERIOR CONTROLS MUST BE STABILIZED IN 7 DAYS.

#### SPECIFICATIONS

- I. SITE PREPARATION
- A) PRIOR TO SEEDING INSTALL ALL REQUIRED SEDIMENT AND EROSION CONTROL MEASURES. B) FINAL GRADING NOT REQUIRED FOR TEMPORARY SEEDING.

#### 2. SOIL AMENDMENTS

- A) FERTILIZER SHALL BE APPLIED AT THE RATE OF 600 LBS./ACRE USING 10-10-10 OR EQUIVALENT.
- B) ACID SOILS SHALL BE LIMED.

#### 3. SEEDBED PREPARATION

A) SOIL SHALL BE LOOSENED TO A DEPTH OF 3 INCHES BY RAKING, DISCING OR OTHER ACCEPTABLE MEANS PRIOR TO SEEDING.

#### 4. SEEDING

A) SELECT A MIXTURE FROM TABLE B.I IN STANDARD SPECIFICATIONS. B) APPLY SEED UNIFORMLY WITH A CYCLONE SEEDER, DRILL, CULTIPACKER SEEDER

#### OR HYDRO SEEDER.

- MULCHING A) MULCH SHALL BE APPLIED IMMEDIATELY AFTER SEEDING. MULCH MATERIALS AND APPLICATIONS SHALL CONFORM TO THE STANDARD SPECIFICATIONS.
  - NOTE: ALL AREAS TO BE ROUGH GRADED AND/OR GRADED ONLY ARE TO BE STABILIZED BY TEMPORARY SEEDING AND MULCHING WITHIN 7 DAYS AFTER GRADING IS COMPLETED, IF PERMANENT SEEDING CANNOT BE PERFORMED AT THAT TIME. THESE AREAS SHALL BE STABILIZED WITH PERMANENT SEEDING AND MULCHING AT THE BEGINNING OF THE NEXT GROWING SEASON.

#### SITE INFORMATION

#### \* (NOT FOR BIDDING PURPOSES)

TOTAL AREA OF SITE	2.1	ACRES
TOTAL AREA DISTURBED _	1.8	ACRES
AREA DISTURBED BY STAGE		
- STAGE I	0.95	ACRES
- STAGE 2	0.08	ACRES
- STAGE 3A _	0.34	ACRES
- STAGE 3B	0.27	ACRES
- STAGE 4	0.30	ACRES
AREA TO BE ROOFED OR PAVED _	0.86	ACRES
TOTAL CUT	2,500	CU. YDS
TOTAL FILL	360	CU. YDS
OFFSITE WASTE/BORROW	10.8	
AREA LOCATION (IF KNOWN)	UNKNOWN	

#### CERTIFICATION OF THE DISTURBED AREA QUANTITY

I hereby certify that the estimated total amount of area to be disturbed shown on these plans has been computed to \_\_\_\_\_2,500 \_\_\_\_ c.y. of excavation, \_\_\_\_\_360 \_\_\_\_ c.y. of fill and the total area to be disturbed as shown on these plans has been determined to be 78,229 square feet, or 1.79 acres.

CARON .	57703
ENGINEER'S SIGNATURE	P.E. NO.
ANDREW K. RINELLA	06/27/2025
PRINT NAME	DATE

**EN-1** 

DEVELOPER/OWNER:

OAKDALE INVESTMENTS, L.L.C. 1355 BEVERLY ROAD, SUITE 240 McLEAN, VIRGINIA 22101 (301) 798-7374 RÀLPH MOBLEY, JR.

FREDERICK COUNTY, MARYLAND TAX MAP 69, L. 8359, F. 128 NEW MARKET ELECTION DISTRICT NO. 9 CREEKSIDE HAMPTONS EAST

**ROUNDABOUT AT GAS HOUSE PIKE AND HIMALAYA ROAD (EAST)** 

**EROSION AND SEDIMENT CONTROL GENERAL NOTES** 

DATE: JUNE 2025

SCALE: N/A

A/P #PW277596

DWG. 26 OF 48

PROFESSIONAL CERTIFICATION. I CERTIFY THAT THIS DOCUMENT WAS PREPARED OR APPROVED BY ME, AND THAT I AM A DULY LICENSED PROFFESIONAL ENGINEER UNDER THE LAWS OF THE STATE OF MARYLAND. **LICENSE NO. 57703 EXPIRATION DATE: 06-08-2027** 





**CONSULTING ENGINEERS** | OWINGS MILLS. MD

# EROSION AND SEDIMENT CONTROL - SEQUENCE OF CONSTRUCTION

## SEQUENCE OF CONSTRUCTION

#### **GENERAL**

- I. THE CONTRACTOR SHALL NOTIFY THE COUNTY ENVIRONMENTAL COMPLIANCE SECTION AT (301) 600-3507. TWO WEEKS PRIOR TO THE START OF CONSTRUCTION FOR AN ON-SITE REVIEW OF PROPOSED EROSION AND SEDIMENT CONTROL MEASURES.
- 2. THE CONTRACTOR SHALL NOTIFY THE MARYLAND DEPARTMENT OF THE ENVIRONMENT (MDE) INSPECTION AND COMPLIANCE PROGRAM AT (410) 537-3510 AND THE COUNTY ENVIRONMENTAL COMPLIANCE SECTION AT (301) 600-3507 SEVEN (7) BUSINESS DAYS BEFORE ANY EARTH DISTURBANCE IN ORDER TO SCHEDULE A PRE-CONSTRUCTION MEETING, AND OBTAIN A COUNTY
- 3. STAKE OUT THE PROJECT FOR THE PRE-CONSTRUCTION MEETING.
- 4. THE EROSION AND SEDIMENT CONTROL SEQUENCE STAGES MUST BE COMPLETED IN CONJUNCTION WITH THE APPROPRIATE MAINTENANCE OF TRAFFIC STAGE.
- 5. THE NOTICE OF INTENT (NOI) SHALL BE IN HAND PRIOR TO THE START OF ANY CONSTRUCTION,

#### STAGE I (SHEET NO. ES-I TO ES-3)

- I. CLEAR AND GRUB FOR THE INSTALLATION OF SCE I-I, SCE I-2, SSF I-I, SSF I-2, SSF I-3, SSF 1-4, SSF 1-5 AND SSF 1-6.
- 2. INSTALL CLEAR WATER DIVERSION PIPE CWDP I-I AND MODIFIED SWALE PROTECTIONS MSP I-I. MSP 1-2, AND MSP 1-3.
- 3. GRADE AND CONSTRUCT HIMALAYA ROAD ENTRANCE.
- 4. INSTALL STORM DRAIN SYSTEM FROM ES-I-I TO MH-I-4, BEGINNING AT THE DOWNSTREAM END PROGRESSING UPSTREAM UNDER DRY CONDITIONS, ONLY CONSTRUCTING WHAT CAN BE STABILIZED BY THE END OF EACH DAY, BLOCK THE ENTRANCE TO 1-1-3 UNTIL STORM WATER POND IS COMPLETED AND STABILIZED.
- 5. GRADE AND INSTALL THE STORM WATER MANAGEMENT FACILITY \*
- 6. INSTALL CURB AND GUTTER ALONG THE EAST AND WEST APPROACHES TO THE PROPOSED TRAFFIC CIRCLE, ON GAS HOUSE PIKE.
- 7. CONSTRUCT FULL DEPTH ASPHALT AND OVERLAY EXISTING ROAD UP TO THE TOP OF ULTIMATE BASE COURSE. AS SHOWN ON THE PLANS.
- \* SWM SGW AREAS CAN BE EXCAVATED, AND STORM DRAIN STRUCTURES INSTALLED WITH PROTECTION. DO NOT INSTALL MEDIA, UNDERGROUND STRUCTURES, ETC. UNTIL THE DRAINAGE AREA TO THE ESD FACILITY IS STABILIZED AND APPROVED BY THE SEDIMENT CONTROL INSPECTOR, NOTE DIVERSION FENCE INSTALLATION MAY BE WARRANTED BY THE INSPECTOR TO PROTECT SEDIMENT FROM ENTERING THE FACILITY.

#### STAGE 2 (SHEET NO. ES-4 TO ES-5)

- I. ESTABLISH WORK ZONES AS SHOWN ON MOT PLANS.
- 2. INSTALL STORM DRAIN SYSTEM FROM MH-I-4 TO I-I-5. BEGINNING AT THE DOWNSTREAM END PROGRESSING UPSTREAM UNDER DRY CONDITIONS, ONLY CONSTRUCTING WHAT CAN BE STABILIZED BY THE END OF EACH DAY, BLOCK THE ENTRANCE TO 1-1-5 UNTIL STORM WATER POND IS COMPLETED AND STABILIZED.
- 3. CONSTRUCT MEDIAN FROM STA. 203+80 TO STA. 204+58 AND STA. 206+50 TO STA. 207+10 UNDER OFF-PEAK FLAGGING OPERATIONS AS DICTATED PER MOT PLANS. ONLY CONSTRUCTING WHAT CAN BE STABILIZED BY THE END OF EACH DAY.
- 4. CONSTRUCT THE REMAINDER OF THE GAS HOUSE PIKE MEDIANS AS SHOWN ON THE PLANS.

## STAGE 3A (SHEET NO. ES-6 TO ES-7)


- I. ESTABLISH WORK ZONES AS SHOWN ON MOT PLANS.
- 2. INSTALL STABILIZED CONSTRUCTION ENTRANCE SCE 3-1.
- 3. INSTALL STORM DRAIN SYSTEM FROM I-I-5 TO I-I-6, BEGINNING AT THE DOWNSTREAM END PROGRESSING UPSTREAM UNDER DRY CONDITIONS, ONLY CONSTRUCTING WHAT CAN BE STABILIZED BY THE END OF EACH DAY, BLOCK THE ENTRANCE TO 1-1-6 UNTIL STORM WATER POND IS COMPLETED AND STABILIZED.
- 4. REMOVE PAVEMENT AS SHOWN ON PLANS AND INSTALL STORM DRAIN FROM 1-1-6 TO STUB AT STA. 83+92 EXTENDING FROM I-I-8. PLUG THE UPSTREAM END OF THE STUB UNTIL NEXT STAGE. BLOCKING THE INLETS UNTIL NEXT STAGE.
- 5. CONSTRUCT THE EASTERN HALF OF SANANDREW DRIVE MEDIAN, THE CURB AND GUTTER, SIDEWALKS AND ROAD UP TO THE TOP OF THE BASE COURSE. AS SHOWN ON THE PLANS. MAINTAINING PUBLIC ACCESS TO WEST WINDS TENNIS CLUB PARKING LOT.

#### STAGE 3B (SHEET NO. ES-8 TO ES-9)

- I. ESTABLISH WORK ZONES AS SHOWN ON MOT PLANS.
- 2. INSTALL STABILIZED CONSTRUCTION ENTRANCE SCE 3-2.
- 3. INSTALL INLET PROTECTIONS CIP 3-1, CIP 3-2, AND CIP 3-3
- 4. REMOVE PAVEMENT AS SHOWN ON PLANS AND INSTALL STORM DRAIN FROM STUB AT STA. 83+92 EXTENDING TO 1-1-9 TO 1-1-11. BLOCKING INLETS UNTIL NEXT STAGE.
- 5. CONSTRUCT THE WESTERN HALF OF SANANDREW DRIVE MEDIAN, THE CURB AND GUTTER, SIDEWALKS AND ROAD UP TO THE TOP OF THE BASE COURSE. AS SHOWN ON THE PLANS.

#### STAGE 4 (SHEET NO. ES-10 TO ES-11)

- I. INSTALL INLET PROTECTIONS CIP 4-1 AND CIP 4-2
- 2. INSTALL STORM DRAIN FROM I-I-II TO I-I-I2. INSTALL INLET PROTECTION CIP 4-3.
- 3. CONSTRUCT THE CURBS AND SIDEWALKS ALONG THE NORTH EDGE OF GAS HOUSE PIKE ON BOTH THE WEST AND EAST APPROACHES TO THE PROPOSED ROUND ABOUT, AS SHOWN ON THE PLANS.
- 4. ESTABLISH WORK ZONE IN INTERSECTION AS SHOWN ON THE PLANS.
- 5. SAWCUT AND CONSTRUCT ROUNDABOUT ISLAND IN THE CENTER OF THE INTERSECTION, AS SHOWN ON THE PLANS.
- 6. LAY FINAL ASPHALT SURFACE COAT OVER THE ENTIRE SITE.
- 7. ONCE WORK IS COMPLETED AND THE SITE IS STABILIZED, WITH THE WRITTEN APPROVAL OF THE COUNTY EROSION AND SEDIMENT CONTROL INSPECTOR, REMOVE ALL SEDIMENT CONTROL DEVISES AND STABILIZE THE DISTURBED AREAS.

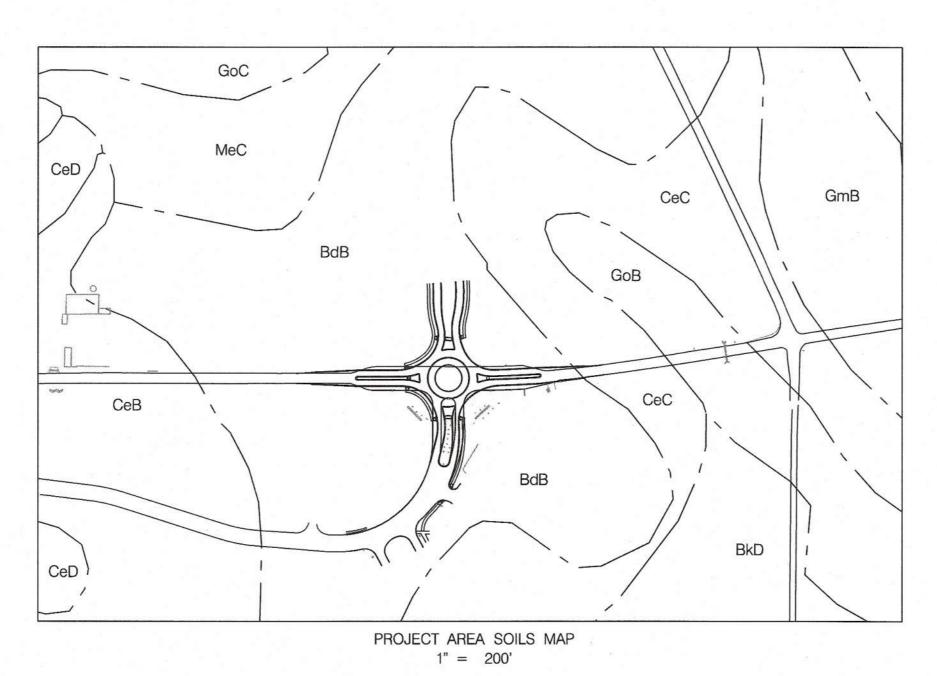

	SOILS TABLE	
MAP UNIT SYMBOL	MAP UNIT NAME	HYDROLOGIC SOIL GROUP
CeB	CHRISTIANA SILT LOAM, 2-5%	В
CeC	CHRISTIANA SILT LOAM, 5-10%	В
CeD	CHRISTIANA SILT LOAM, 10-25%	В
GmB	GALESTOWN - URBAN LAND COMPLEX, 0-8%	В
BdB	BEDINGTON SHALY SILT LOAM, 3-8%	С
BkD	BERKS-WEIKERT COMPLEX, 15-25%	С
MeC	MERRIMAC SANDY LOAM, 8-15%	С
GoB	GLENELG – URBAN LAND COMPLEX, 0–8%	D
GoC	GEOGENIC ORGANIC CARBON	D

## STANDARD SYMBOLS

AT-GRADE INLET PROTECTION	AGIP	ROCK OUTLET PROTECTION I	ROPI
BAFFLE BOARDS	ВВ	ROCK OUTLET PROTECTION II	ROPII
BENCHING	BENCHING	ROCK OUTLET PROTECTION III	ROPIII
CATCH BASIN INSERT	[]сві	SILT FENCE	⊢——SF———
CLEAR WATER DIVERSION PIPE	CWD - 12  DESIGNATION CWD-12 REFERS TO 12 NCH CLEAR WATER DIVERSION.	SILT FENCE ON PAVEMENT	SF0P
CLEAR WATER PIPE	⊢∏-I	SOD	* * * * * * * * * * * * * * * * * * * *
COMBINATION INLET PROTECTION	COIP	STABILIZED CONSTRUCTION ENTRANCE	SCE SCE
CONCRETE WASHOUT STRUCTURE	CWS	STANDARD INLET PROTECTION	[_] SIP
CURB INLET PROTECTION	[ <del>Z</del> ]ar	STOCKPILE AREA	
DIVERSION FENCE	├── DF ──	STONE CHECK DAM	CD
EARTH DIKE	A-I PLACE DESIGNATION (A-I, B-2, etc.) ON FLOW CHANNEL SIDE OF DIKE.	STONE/RIPRAP OUTLET SEDIMENT TRAP ST II	ST-II
EMERGENCY SPILLWAY	ES	SUBSURFACE DRAINS	⊢ − SSD − ⊣
FILTER BAG	⊠FB	SUMP PIT	⊠SP
FILTER BERM	IFB-AI IFB-BI	SUPER SILT FENCE	⊢—SSF——I
FILTER LOG	► FL-18 ← TDESIGNATION FL-18 REFERS TO 18 INCH DIAMETER FILTER LOG.	TEMPORARY ACCESS BRIDGE	ТВ
GABION INFLOW PROTECTION	GP	TEMPORARY ACCESS CULVERT	
GABION INLET PROTECTION	[ GIP	TEMPORARY ASPHALT BERM	TAB
HORIZONTAL DRAW-DOWN DEVICE	HDDD	TEMPORARY BARRIER DIVERSION	ТВО
LIMIT OF CUT	-cc-	TEMPORARY GABION OUTLET STRUCTURE	TGOS
LIMIT OF DISTURBANCE	LOD	TEMPORARY SOIL STABILIZATION MATTING-TYPE	A A A A
LIMIT OF FILL	—F ——F —	TEMPORARY SOIL STABILIZATION MATTING-TYPE	E E E
MEDIAN INLET PROTECTION		TEMPORARY SOIL STABILIZATION MATTING-TYPE	D
MEDIAN SUMP INLET PROTECTION	MSIP	TEMPORARY STONE OUTLET STRUCTURE	<b>₹</b> TSOS
MODIFIED SWALE PROTECTION	MSP	TEMPORARY SWALE	A-I  E DESIGNATION (A-I, B-2, etc.) LOW CHANNEL SIDE OF SWALE,
MOUNTABLE BERM	MB	WASH RACK OPTION	
PERIMETER DIKE/SWALE	PDS-1 ←	DRAINAGE BOUNDARY	DA
PERMANENT SOIL STABILIZATION MATTING-T	YPE B	EXISTING CONTOURS	
PERMANENT SOIL STABILIZATION MATTING-T	YPE C	PROPOSED CONTOURS	100
PIPE OUTLET SEDIMENT TRAP ST I	ST-I	TREE PROTECTION FENCE	— TPF —
PIPE SLOPE DRAIN	PSD - 12  DESIGNATION PSD-12 REFERS TO 12 INCH PIPE SLOPE DRAIN.	WETLAND	• • • • •
PLUNGE POOL	PP	WETLAND BUFFER	— в —
PORTABLE SEDIMENT TANK	⊠PST	100-YEAR FLOODPLAIN	<del></del>
REMOVABLE PUMPING STATION	⊠RPS		
RIPRAP INFLOW PROTECTION	€ RRP 3		
RIPRAP OUTLET SEDIMENT TRAP ST III	ST-III		

**Frederick County Soil Conservation District** Erosion and Sediment Control Plan Approval

Hum District Manager or Designee 8/25/2025

Plan is valid for 2 years from date of approval

SCD approval for erosion and sediment control is in accordance with the 2011 Maryland Standards and Specifications for Soil Erosion and Sediment Control and is contingent upon issuance of all applicable regulatory permits.

PROFESSIONAL CERTIFICATION. I CERTIFY THAT THIS DOCUMENT WAS PREPARED OR APPROVED BY ME, AND THAT I AM A DULY LICENSED PROFFESIONAL ENGINEER UNDER THE LAWS OF THE STATE OF MARYLAND. LICENSE NO. 57703 **EXPIRATION DATE: 06-08-2027** 





DEVELOPER/OWNER:

OAKDALE INVESTMENTS, L.L.C.

1355 BEVERLY ROAD, SUITE 240 McLEAN, VIRGINIA 22101

(301) 798-7374 RALPH MOBLEY, JR.

FREDERICK COUNTY, MARYLAND TAX MAP 69, L. 8359, F. 128 NEW MARKET ELECTION DISTRICT NO. 9

**CREEKSIDE HAMPTONS EAST ROUNDABOUT AT GAS HOUSE PIKE AND HIMALAYA ROAD (EAST)** 

**EROSION AND SEDIMENT CONTROL GENERAL NOTES &** SEQUENCE OF CONSTRUCTION

A/P #PW277596

DATE: JUNE 2025

DWG. 27 OF 48

SCALE: N/A

**EN-2** 

DETAIL E-9-3 CURB INLET

6 FT MAX. SPACING OF 2 IN x 4 IN SPACERS

- 2 IN x 4 IN WEIR

2. USE NONWOVEN GEOTEXTILE AS SPECIFIED IN SECTION H-1 MATERIALS.

WEIR, EXTENDING IT 2 FEET BEYOND THROAT ON EACH SIDE

3. NAIL THE 2x4 WEIR TO 9 INCH LONG VERTICAL SPACERS (MAXIMUM 6 FEET APART).

CLOTH OVER THE HARDWARE CLOTH AND SECURELY ATTACH TO THE 2x4 WEIR.

**ISOMETRIC** 

. USE NOMINAL 2 INCH x 4 INCH LUMBER

OTHER APPROVED ANCHORING METHOD.

STONE OR EQUIVALENT RECYCLED CONCRETE.

CONSTRUCTION SPECIFICATIONS

2 IN x 4 IN ANCHORS, 2 FT MIN. LENGTH

- 2 IN x 4 IN SPACER

30 INCHES AND A MINIMUM LENGTH OF 4 FEET LONGER THAN THE THROAT OPENING, TO THE 2x4

PLACE THE ASSEMBLY AGAINST THE INLET THROAT AND NAIL TO 2x4 ANCHORS (MINIMUM 2 FEET LENGTH). EXTEND THE ANCHORS ACROSS THE INLET TOP AND HOLD IN PLACE BY SANDBAGS OR

AT NON-SUMP LOCATIONS, INSTALL A TEMPORARY SANDBAG OR ASPHALT BERM TO PREVENT INLET


SEDIMENT AFTER EACH RAIN EVENT TO MAINTAIN FUNCTION AND AVOID PREMATURE CLOGGING. IF INLET PROTECTION DOES NOT COMPLETELY DRAIN WITHIN 24 HOURS AFTER A STORM EVENT, IT IS


STORM DRAIN INLET PROTECTION REQUIRES FREQUENT MAINTENANCE. REMOVE ACCUMULATED


INSTALL END SPACERS A MINIMUM OF 1 FOOT BEYOND THE ENDS OF THE THROAT OPENING.


2 IN x 4 IN WEIR-


¾ TO 1½ STONE -

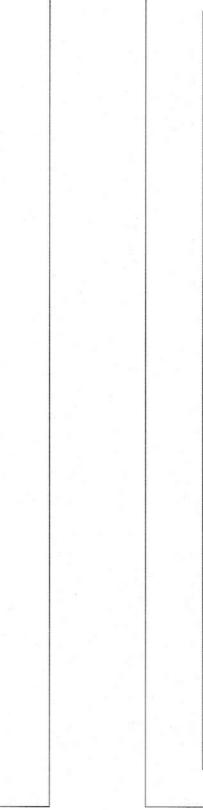


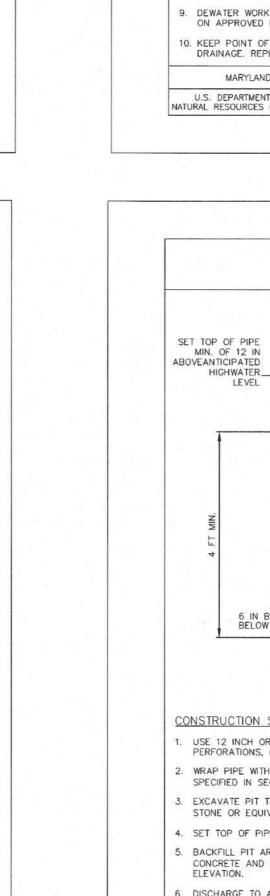


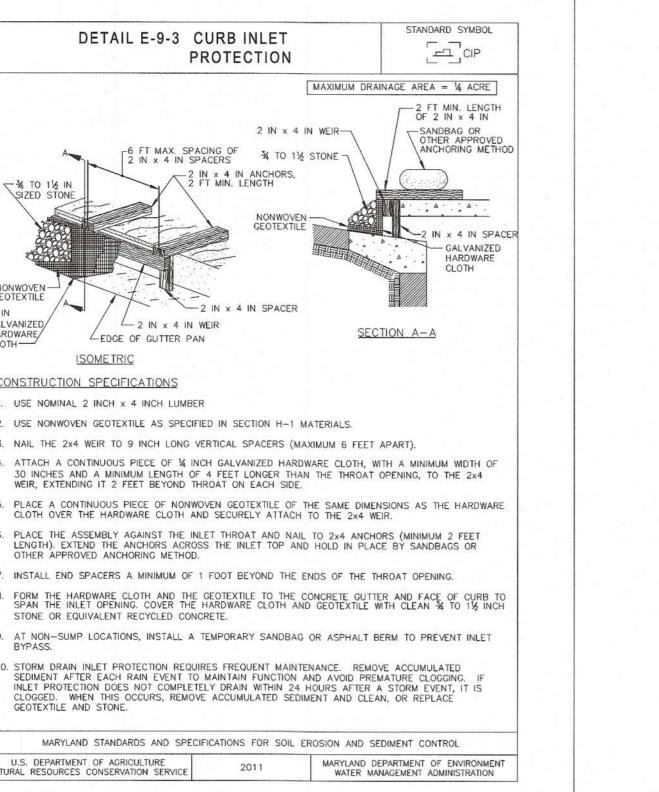


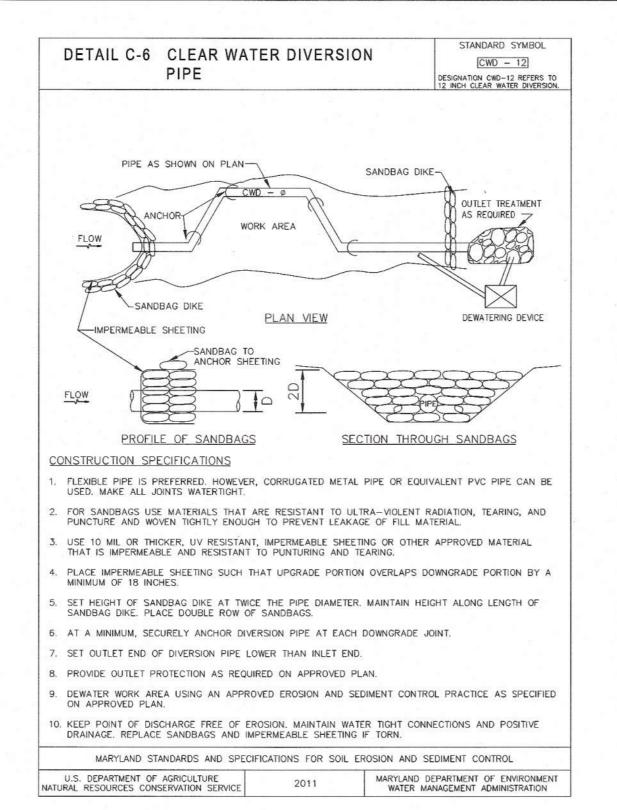


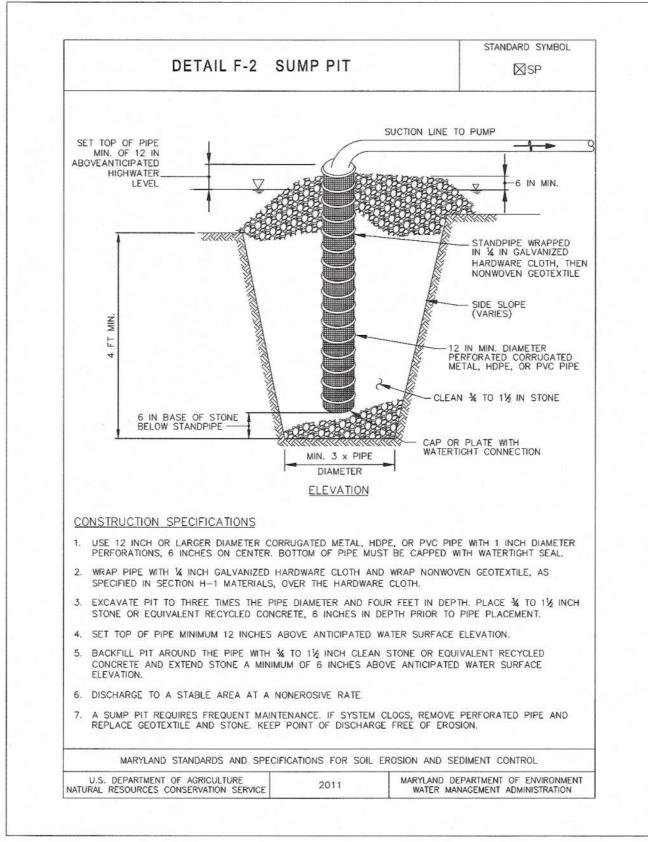

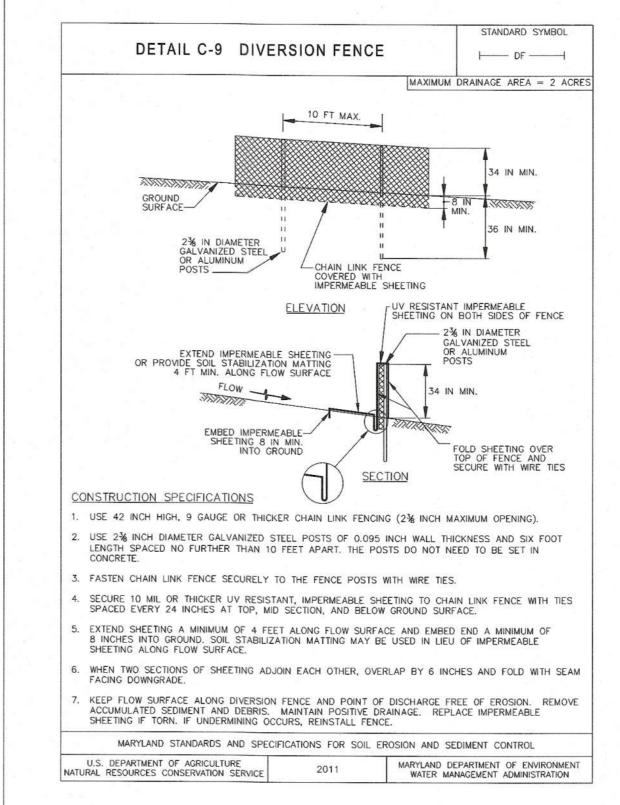

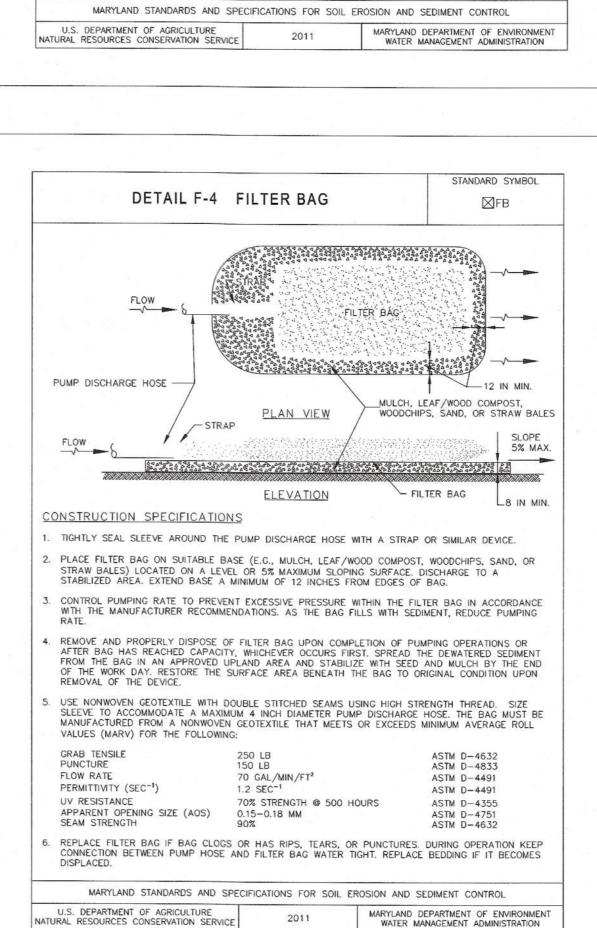

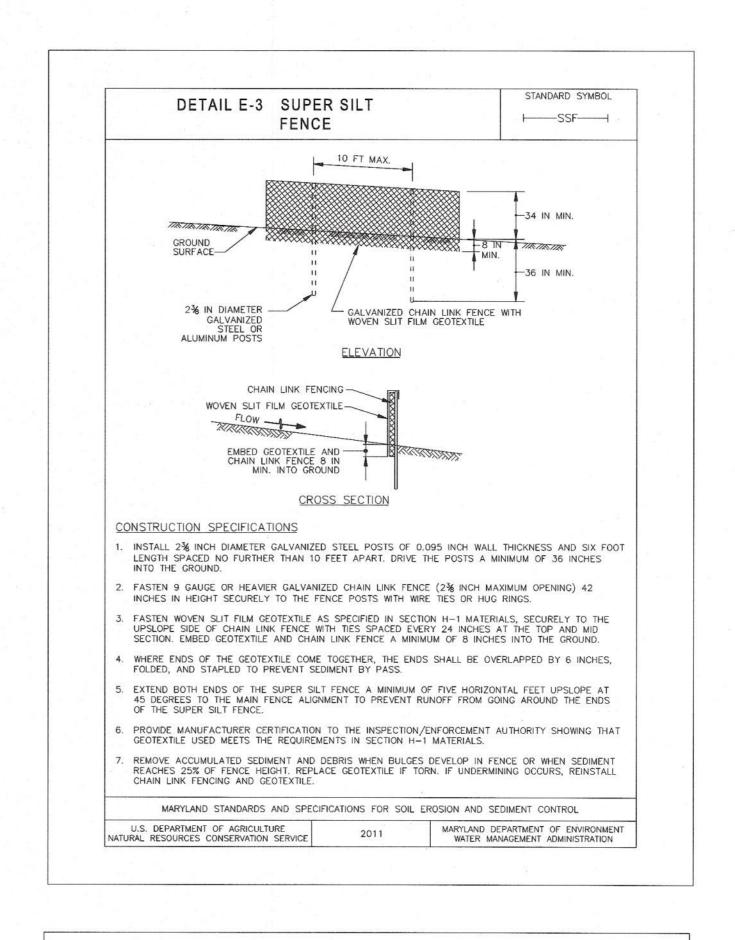

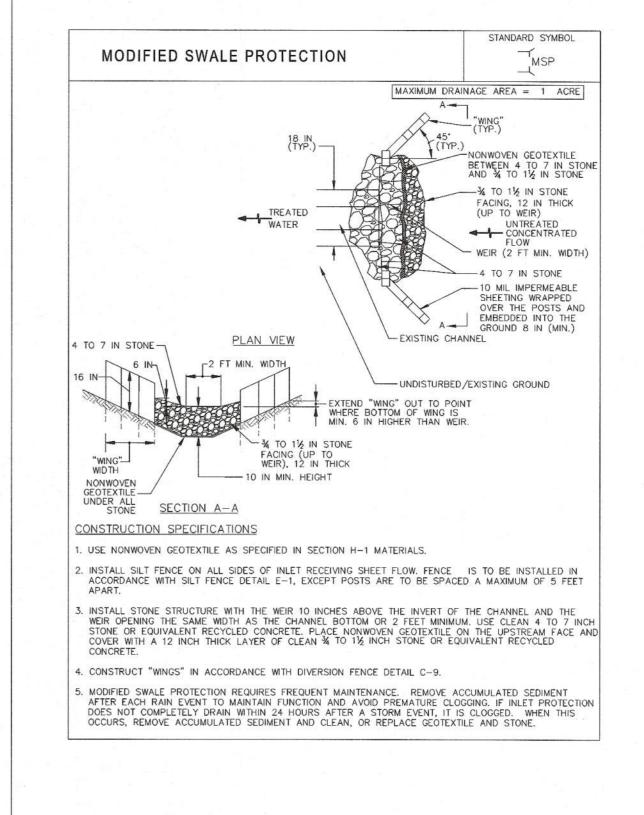

FREDERICK COUNTY, MARYLAND TAX MAP 69, L. 8359, F. 128 NEW MARKET ELECTION DISTRICT NO. 9

**CREEKSIDE HAMPTONS EAST ROUNDABOUT AT GAS HOUSE PIKE AND HIMALAYA ROAD (EAST)** 

**EROSION AND SEDIMENT CONTROL** 

SCALE: N/A

STANDARD DETAILS DATE: JUNE 2025

PROFESSIONAL CERTIFICATION. I CERTIFY THAT THIS DOCUMENT WAS PREPARED OR APPROVED BY ME, AND THAT I AM A DULY LICENSED PROFFESIONAL ENGINEER UNDER THE LAWS OF THE STATE OF MARYLAND. **LICENSE NO. 57703 EXPIRATION DATE: 06-08-2027** 





**CONSULTING ENGINEERS** | OWINGS MILLS, MD

DEVELOPER/OWNER:

OAKDALE INVESTMENTS, L.L.C.

1355 BEVERLY ROAD, SUITE 240 McLEAN, VIRGINIA 22101

(301) 798-7374

RALPH MOBLEY, JR.

regulatory permits.

WHEN THIS OCCURS, REMOVE ACCUMULATED SEDIMENT AND CLEAN, OR REPLACE MARYLAND STANDARDS AND SPECIFICATIONS FOR SOIL EROSION AND SEDIMENT CONTROL U.S. DEPARTMENT OF AGRICULTURE
NATURAL RESOURCES CONSERVATION SERVICE MARYLAND DEPARTMENT OF ENVIRONMENT

SECTION A-A

Frederick County Soil Conservation District Erosion and Sediment Control Plan Approval

District Manager or Designee 8/25/2025

EOTEXTIL

Plan is valid for 2 years from date of approval

SCD approval for erosion and sediment control is in accordance with the 2011 Maryland Standards and Specifications for Soil Erosion and Sediment Control and is contingent upon issuance of all applicable


A/P #PW277596

DWG. 28 OF 48

ED-1

Division of Planning and Permitting
Department of Development
Review Engineering
APPROVED: 9/8/2025
Signature:

SOIL TYPE

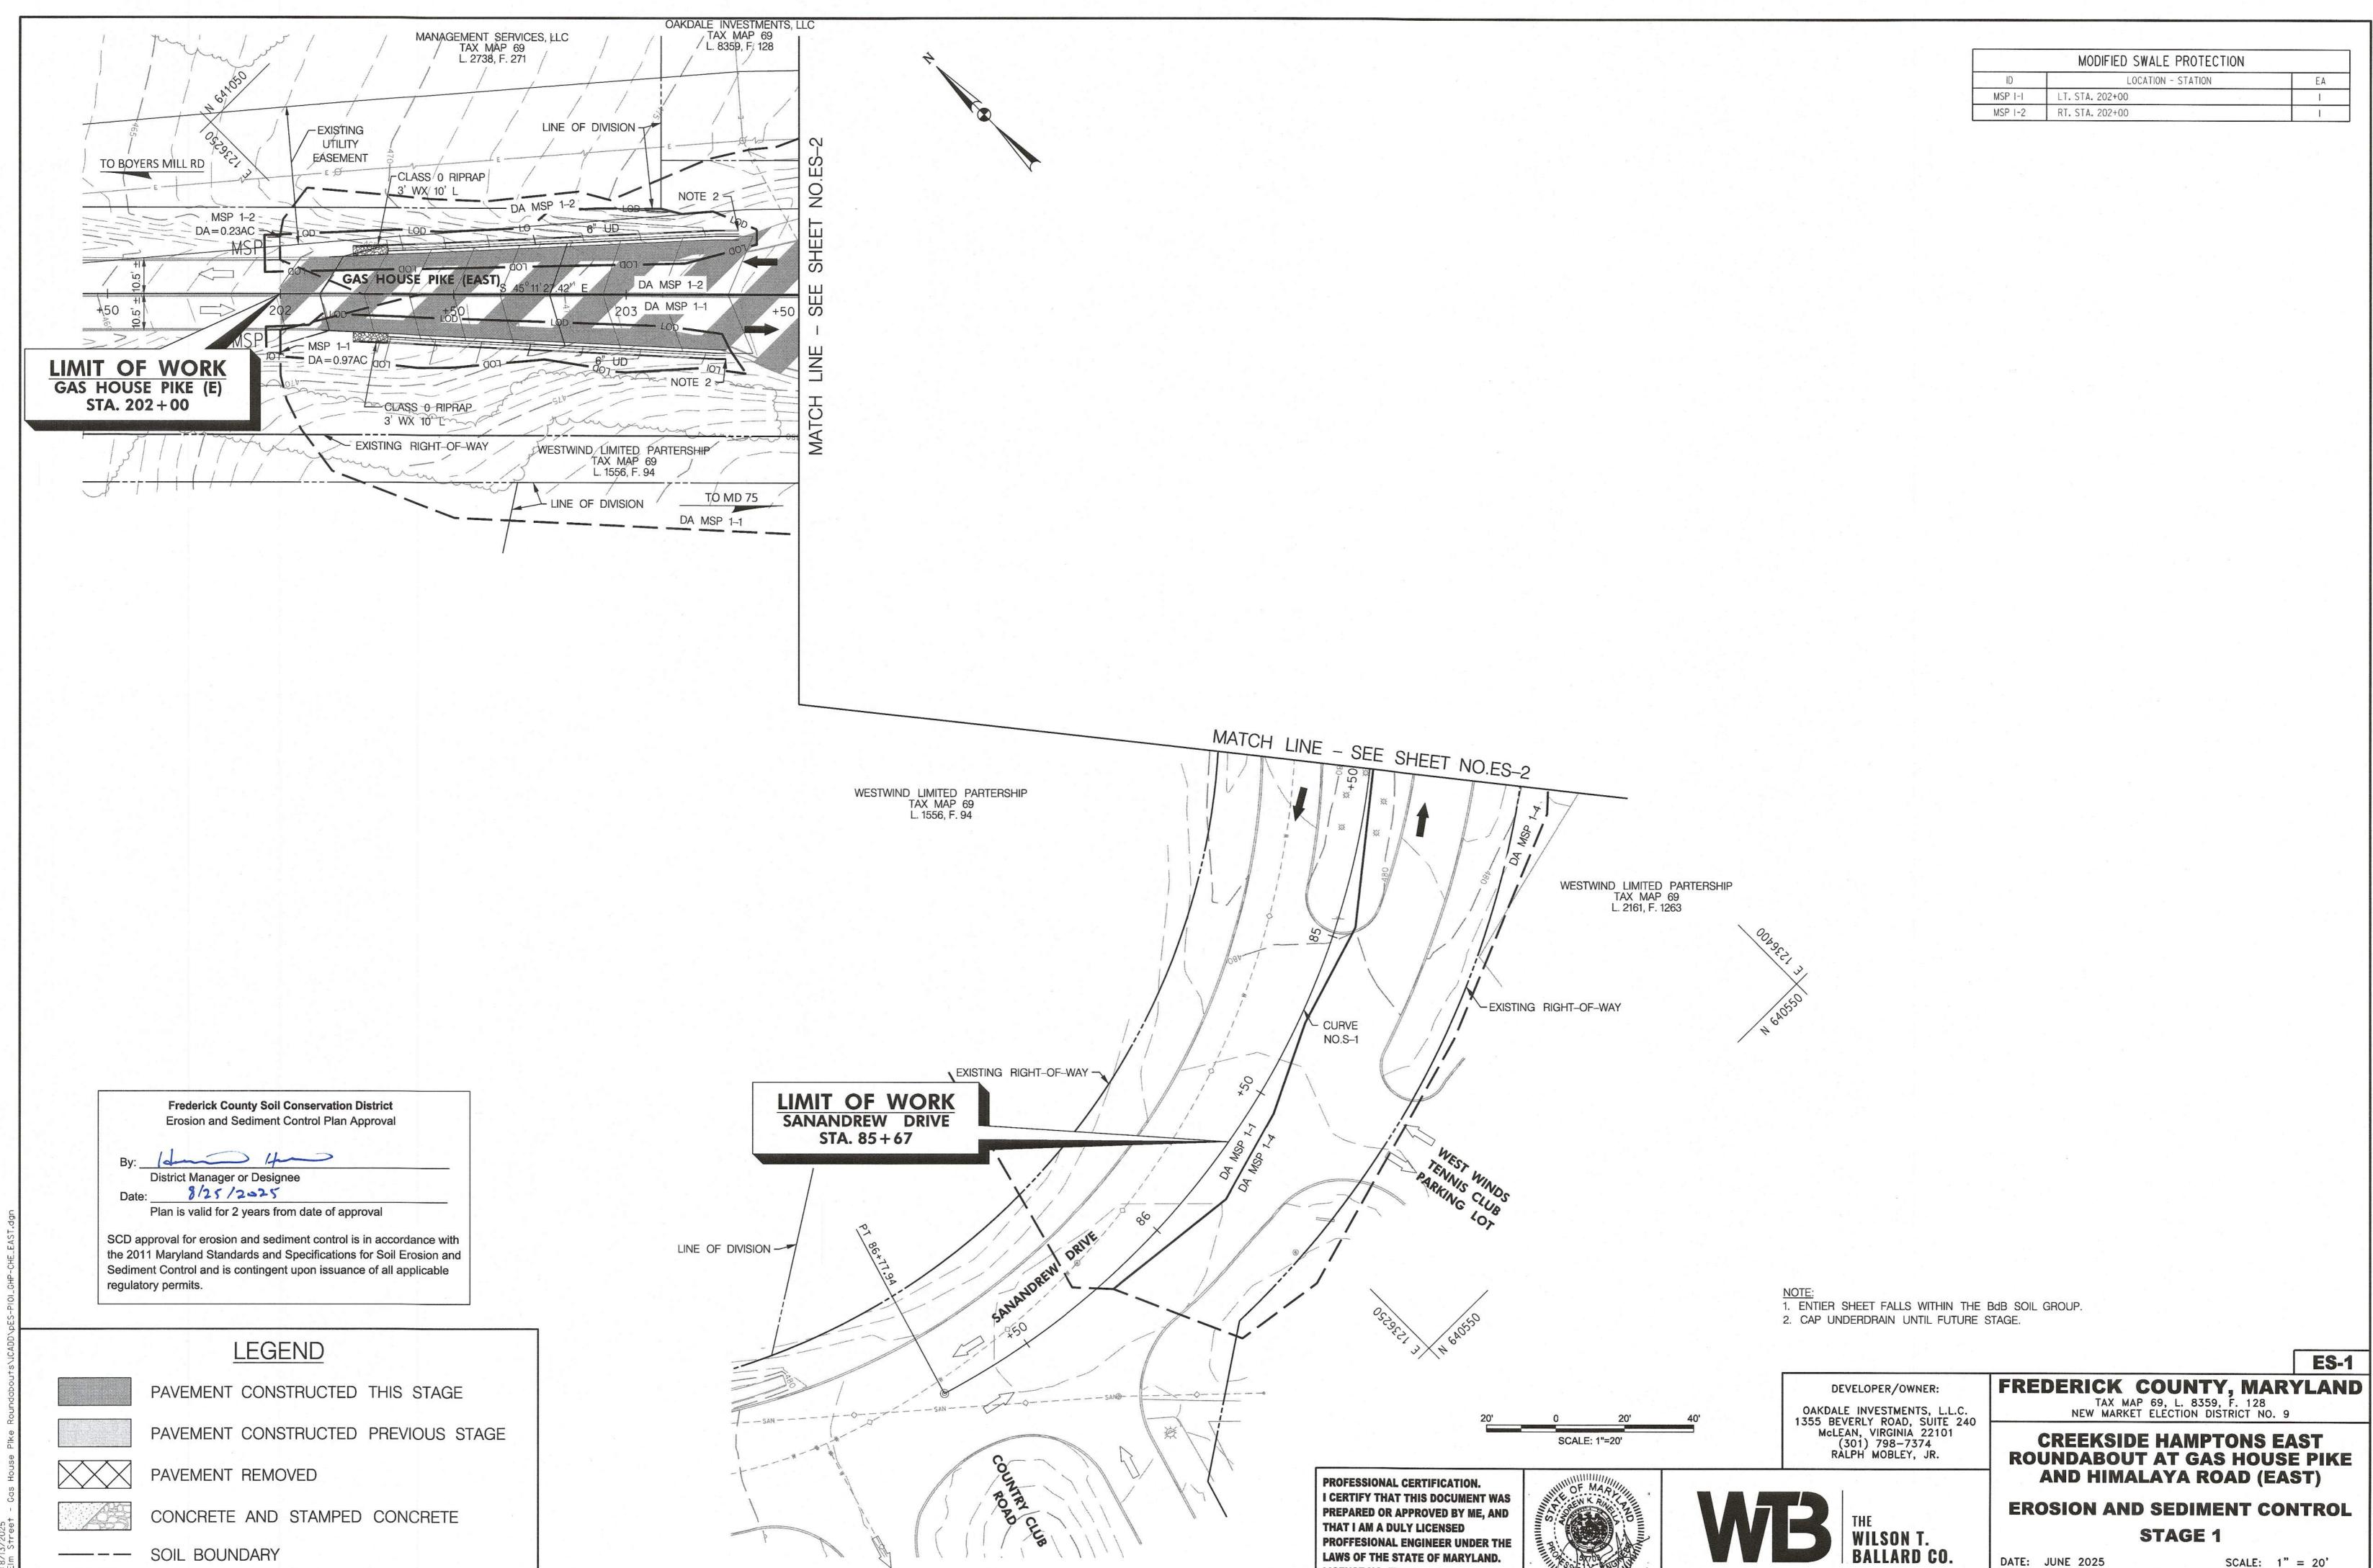

LICENSE NO. 57703


**EXPIRATION DATE: 06-08-2027** 

DWG. 29 OF 48

A/P #PW277596

CONSULTING ENGINEERS | OWINGS MILLS, MD



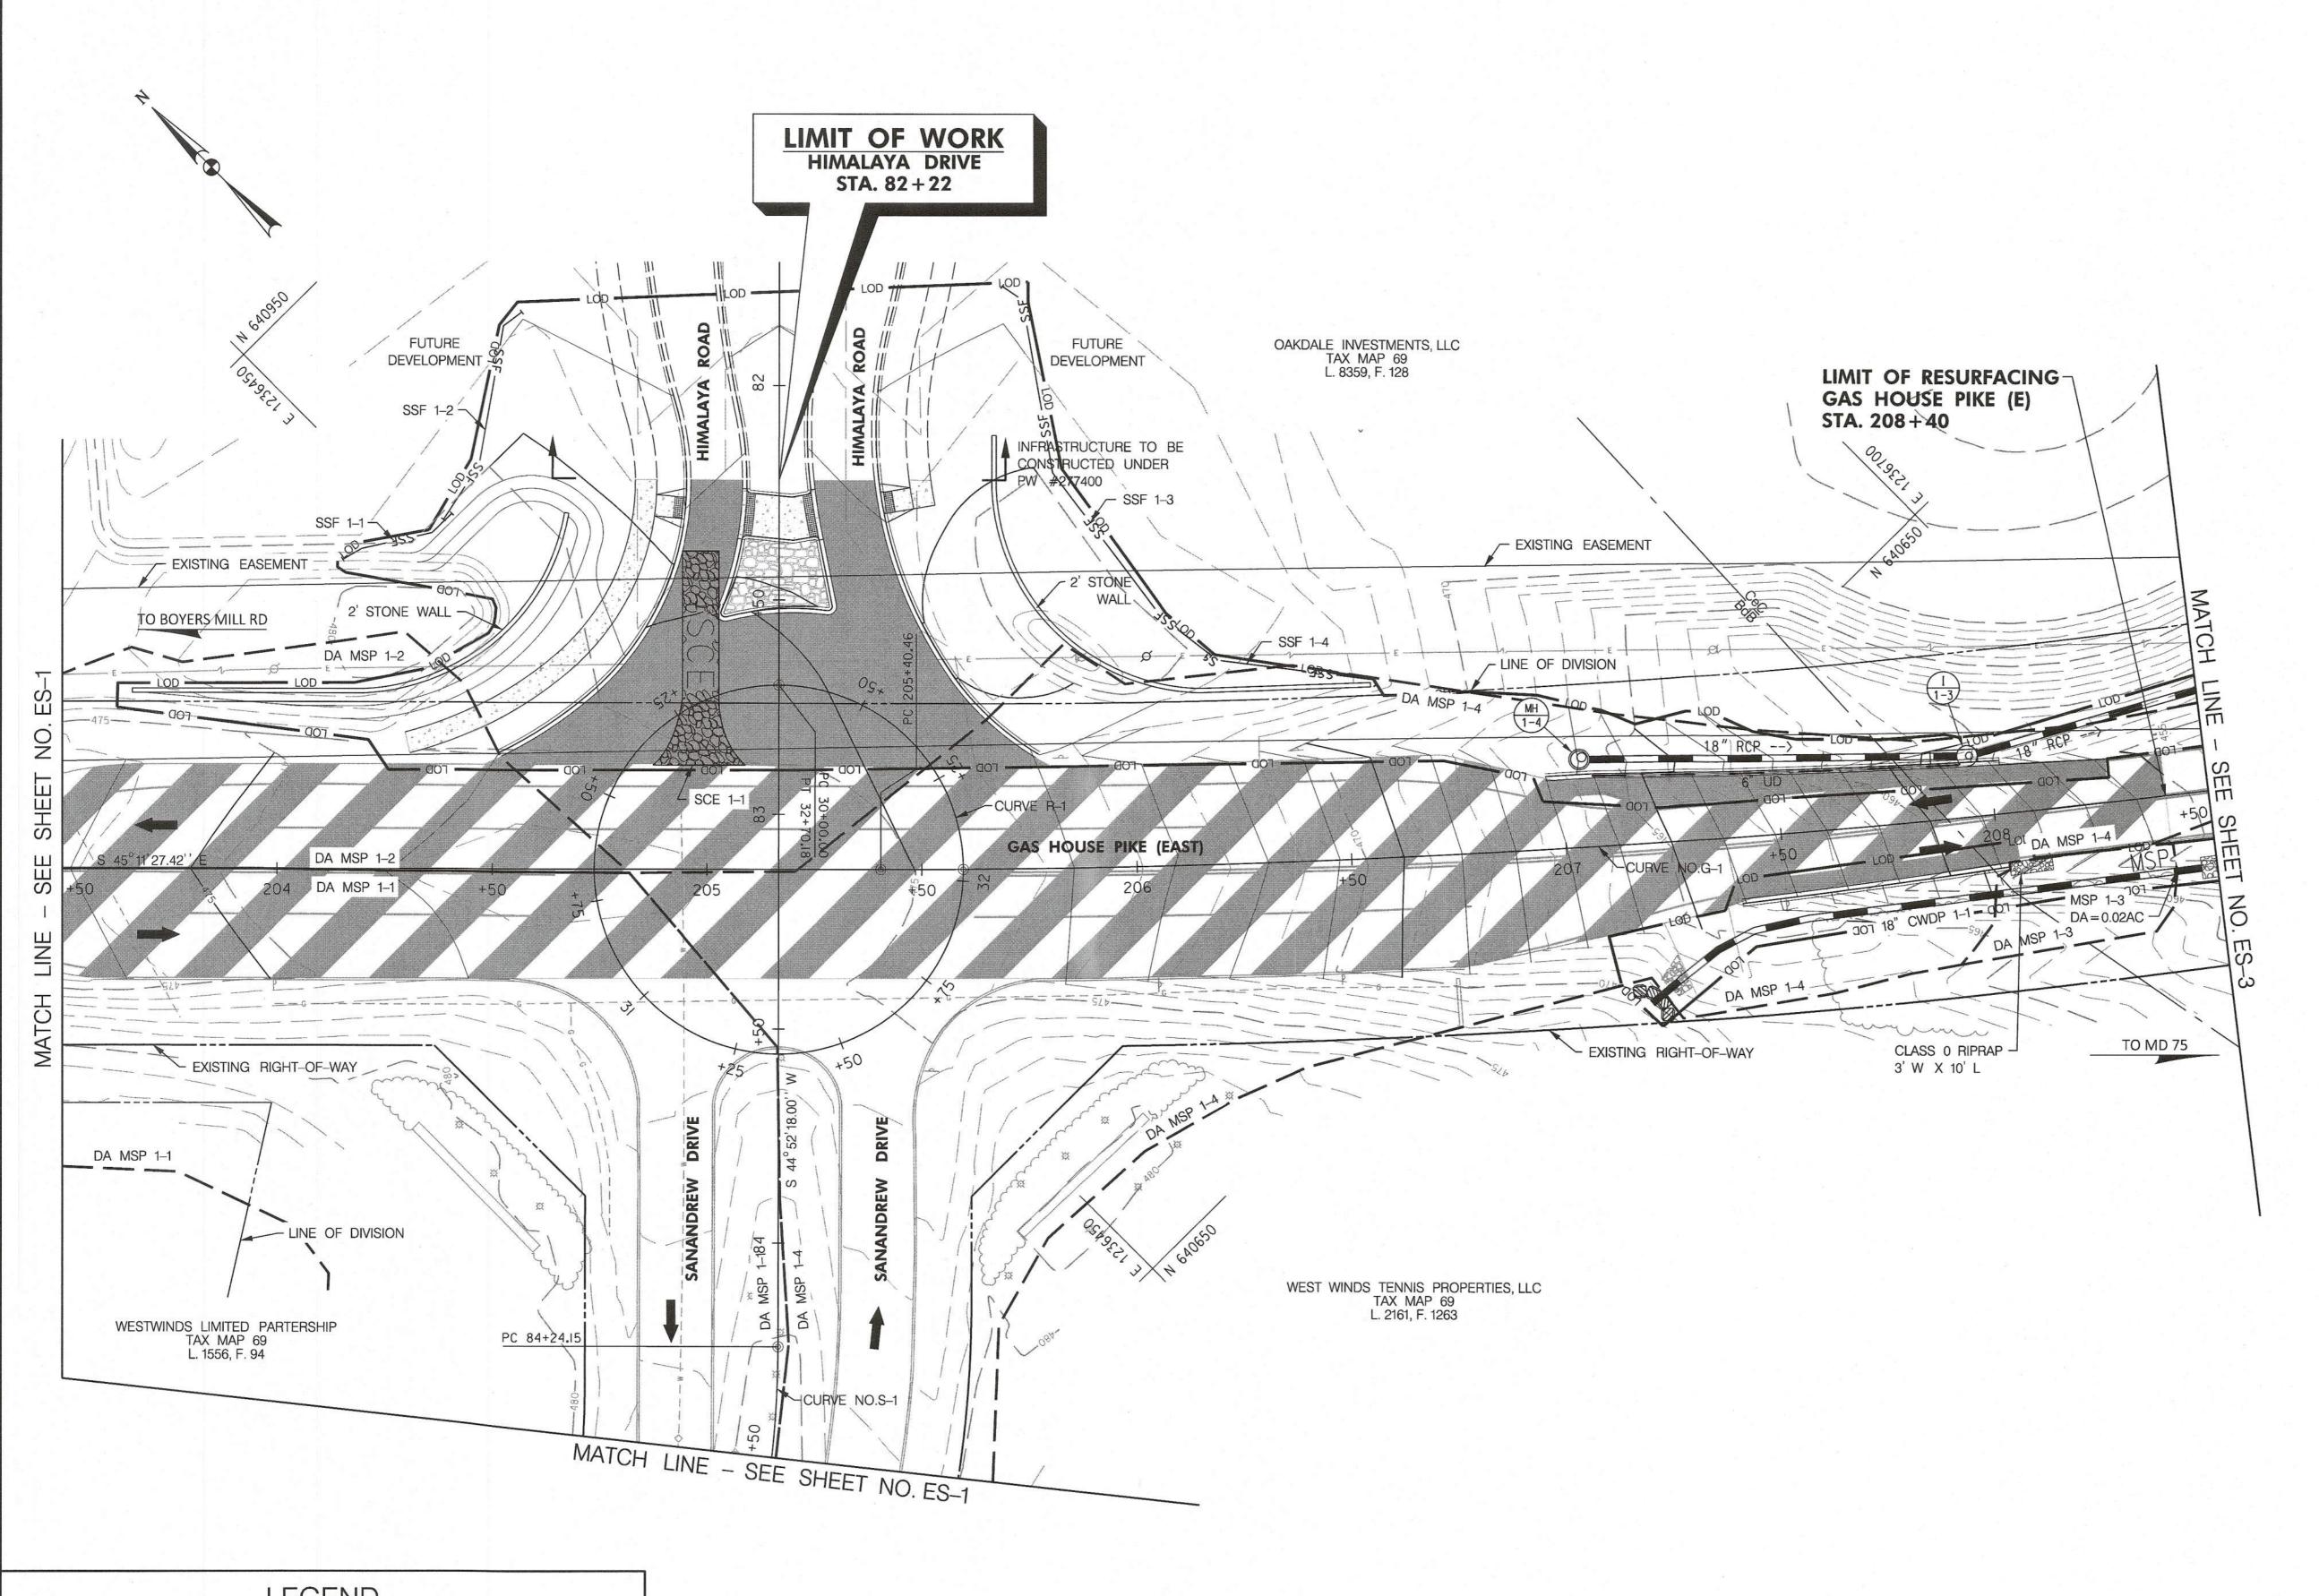

STABILIZED CONSTRUCTION ENTERANCE LOCATION - STATION LT. STA. 204+99

SUPER SILT FENCE		
ID	LOCATION - STATION	LF
SSF I-I	LT. STA. 204+15 TO LT. STA. 204+40	28
SSF 1-2	LT. STA. 204+39 TO LT. STA. 204+57	54
SSF I-3	LT. STA. 205+69 TO LT. STA. 206+18	103
SSF 1-4	LT. STA. 206+18 TO LT. STA. 206+57	41

	MODIFIED SWALE PROTECTION	
ID	LOCATION - STATION	EA
MSP 1-3	RT. STA. 208+40	1

CLEAR WATER DIVERSION PIPE		
ID	LOCATION - STATION	LF
18" CWDP 1-1	RT. STA. 207+18 TO RT. STA. 208+47	135

LEGEND

PAVEMENT CONSTRUCTED THIS STAGE

PAVEMENT CONSTRUCTED PREVIOUS STAGE

PAVEMENT REMOVED

CONCRETE AND STAMPED CONCRETE


SOIL BOUNDARY SOIL TYPE

Frederick County Soil Conservation District Erosion and Sediment Control Plan Approval

By: John How District Manager or Designee Date: 8/25/2025

Plan is valid for 2 years from date of approval

SCD approval for erosion and sediment control is in accordance with the 2011 Maryland Standards and Specifications for Soil Erosion and Sediment Control and is contingent upon issuance of all applicable regulatory permits.

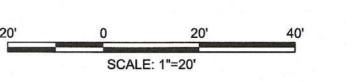

DEVELOPER/OWNER:

FREDERICK COUNTY, MARYLAND

TAX MAP 69, L. 8359, F. 128

NEW MARKET ELECTION DISTRICT NO. 9 OAKDALE INVESTMENTS, L.L.C. 1355 BEVERLY ROAD, SUITE 240 McLEAN, VIRGINIA 22101 (301) 798-7374 RALPH MOBLEY, JR.

**CREEKSIDE HAMPTONS EAST ROUNDABOUT AT GAS HOUSE PIKE AND HIMALAYA ROAD (EAST)** 


**EROSION AND SEDIMENT CONTROL** STAGE 1

DATE: JUNE 2025 A/P #PW277596

SCALE: 1" = 20DWG. 30 OF 48


**ES-2** 

PROFESSIONAL CERTIFICATION. I CERTIFY THAT THIS DOCUMENT WAS PREPARED OR APPROVED BY ME, AND THAT I AM A DULY LICENSED PROFFESIONAL ENGINEER UNDER THE LAWS OF THE STATE OF MARYLAND. **LICENSE NO. 57703** EXPIRATION DATE: 06-08-2027

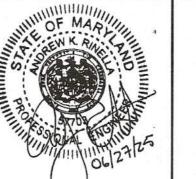





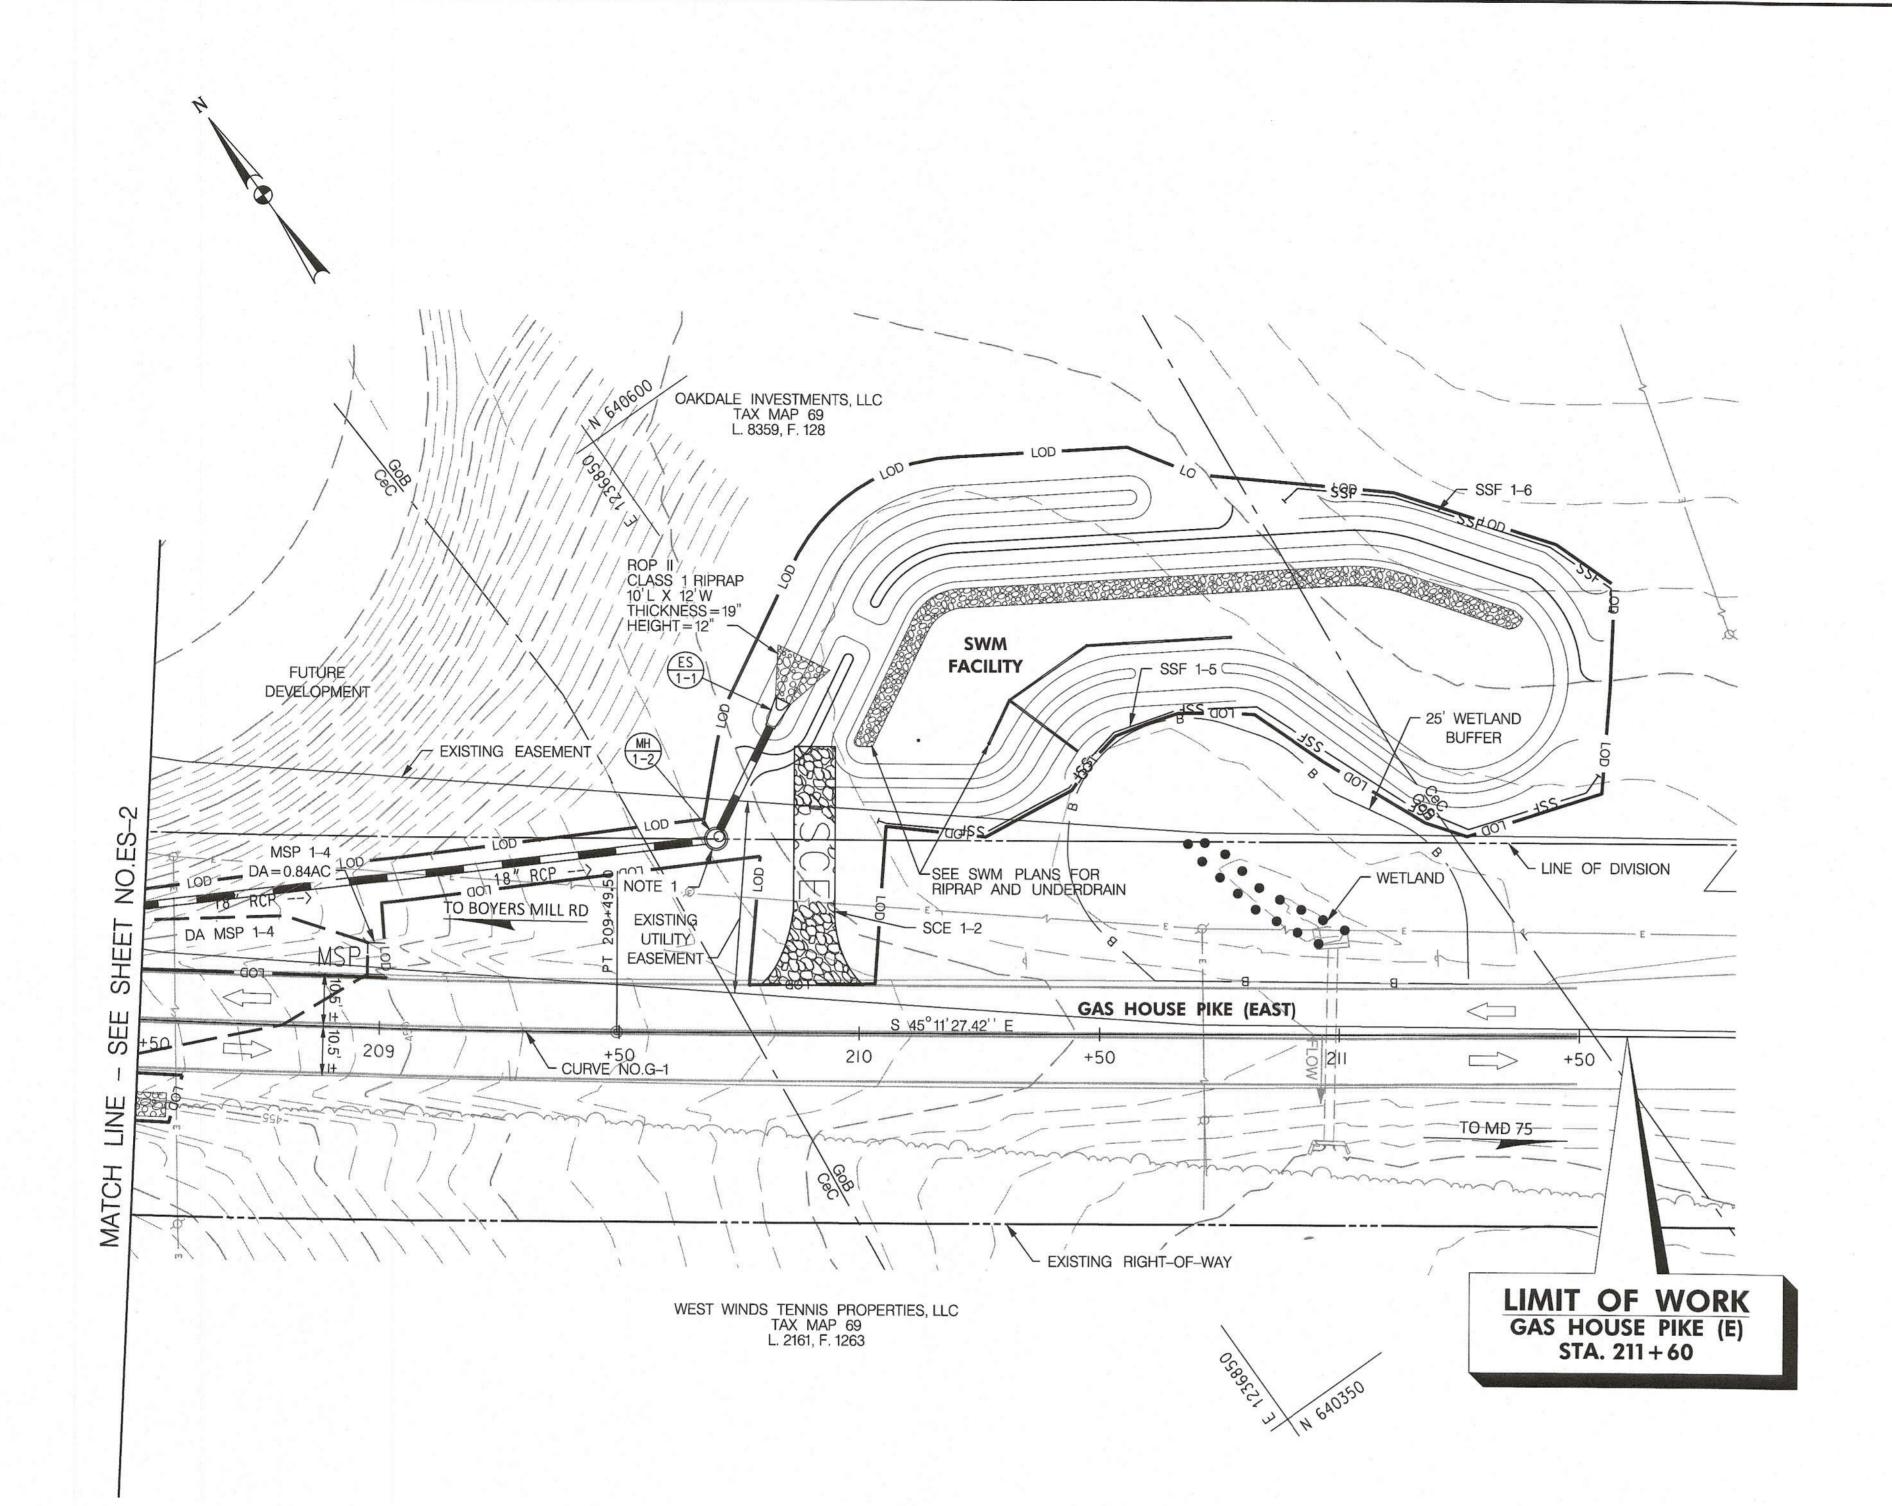

STABILIZED CONSTRUCTION ENTERANCE LOCATION - STATION SCE 1-2 LT. STA. 209+90 SUPER SILT FENCE ID LOCATION - STATION LT. STA. 210+04 TO LT. STA. 211+54 170 SSF 1-6 LT. STA. 210+88 TO LT. STA. 211+56 78

	MODIFIED SWALE PROTECTION	
ID	LOCATION - STATION	EA
MSP 1-4	LT. STA. 208+97	

## **LEGEND**




PAVEMENT CONSTRUCTED THIS STAGE




PAVEMENT CONSTRUCTED PREVIOUS STAGE



PAVEMENT REMOVED

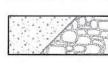

CONCRETE AND STAMPED CONCRETE

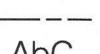

SOIL BOUNDARY SOIL TYPE


Frederick County Soil Conservation District Erosion and Sediment Control Plan Approval



Date: 8/25 / 2025 Plan is valid for 2 years from date of approval

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**CONSULTING ENGINEERS | OWINGS MILLS, MD** 

DEVELOPER/OWNER:
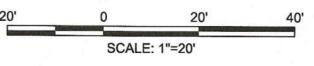
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FREDERICK COUNTY, MARYLAND

TAX MAP 69, L. 8359, F. 128

NEW MARKET ELECTION DISTRICT NO. 9

**CREEKSIDE HAMPTONS EAST ROUNDABOUT AT GAS HOUSE PIKE AND HIMALAYA ROAD (EAST)** 

**EROSION AND SEDIMENT CONTROL** STAGE 1

DATE: JUNE 2025

SCALE: 1" = 20'

ES-3

A/P #PW277596 DWG. 31 OF 48

PROFESSIONAL CERTIFICATION. I CERTIFY THAT THIS DOCUMENT WAS

PREPARED OR APPROVED BY ME, AND

PROFFESIONAL ENGINEER UNDER THE


LAWS OF THE STATE OF MARYLAND.

THAT I AM A DULY LICENSED

**EXPIRATION DATE: 06-08-2027** 

LICENSE NO. 57703




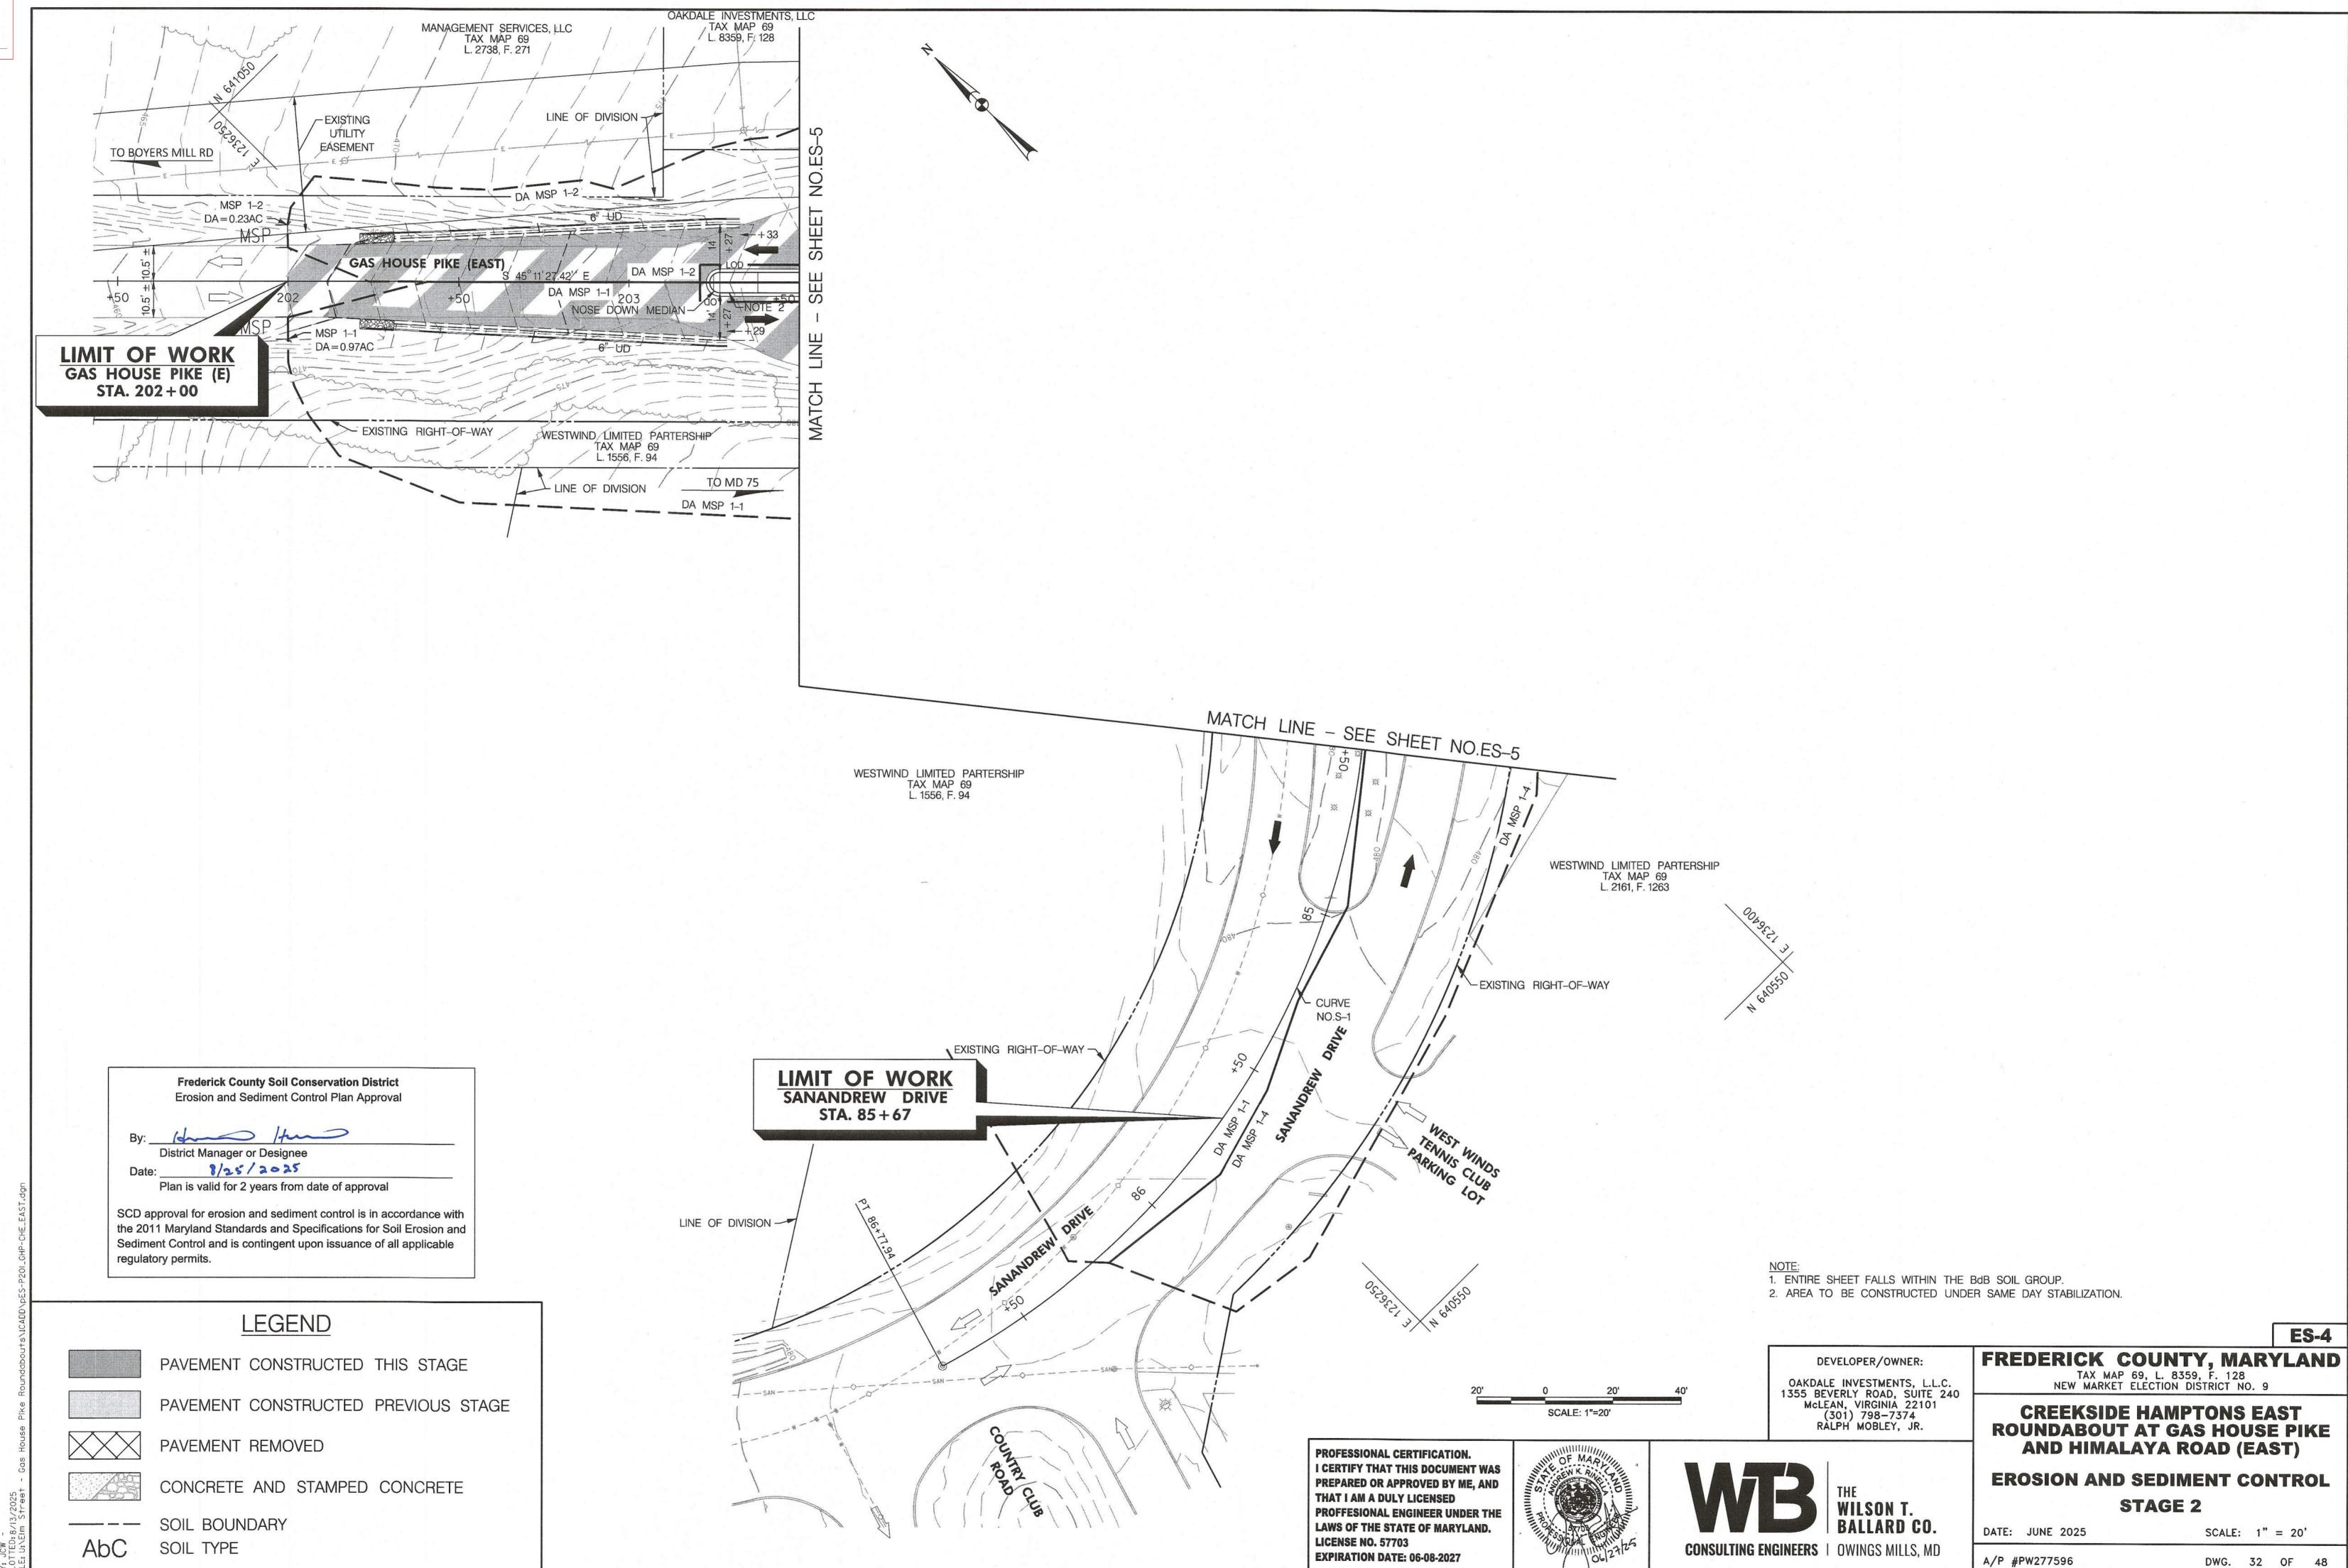

A/P #PW277596

DWG. 32 OF 48



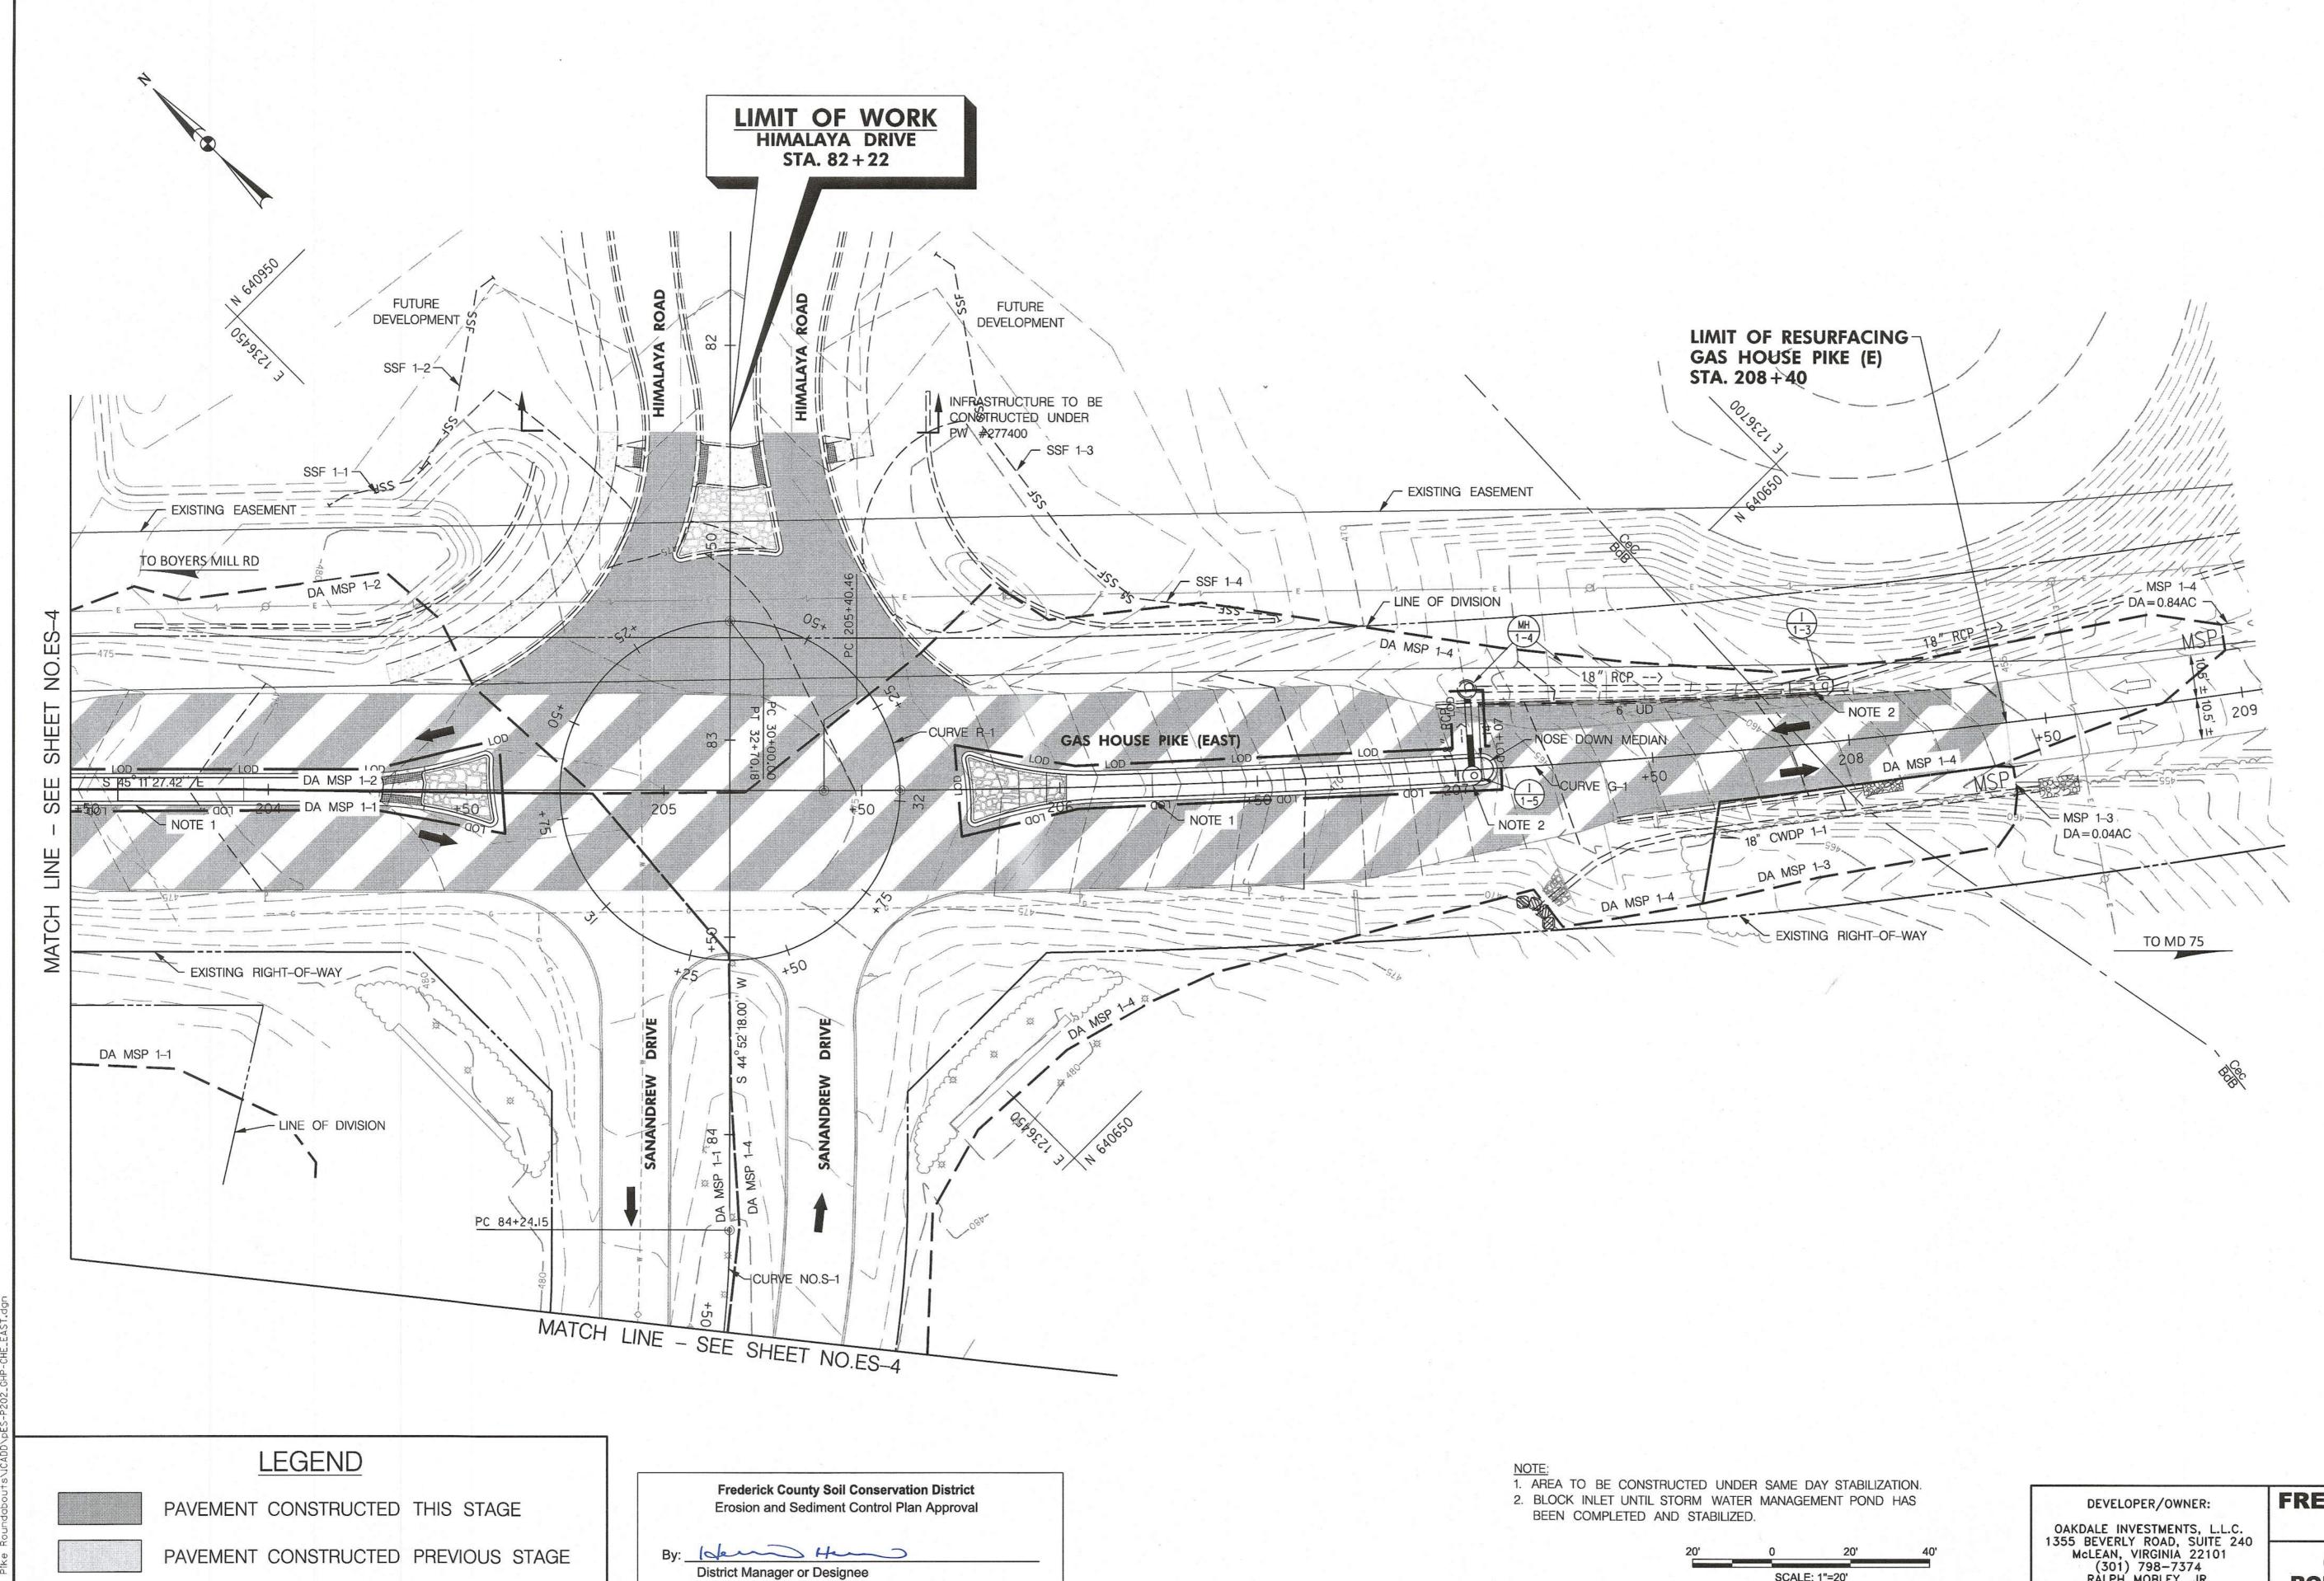




PAVEMENT REMOVED

CONCRETE AND STAMPED CONCRETE

---- SOIL BOUNDARY SOIL TYPE

Date: 8/25/2025 Plan is valid for 2 years from date of approval

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OAKDALE INVESTMENTS, L.L.C. 1355 BEVERLY ROAD, SUITE 240 McLEAN, VIRGINIA 22101 (301) 798-7374 RALPH MOBLEY, JR.

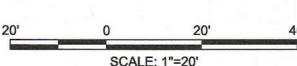**CONSULTING ENGINEERS** | OWINGS MILLS, MD

FREDERICK COUNTY, MARYLAND

TAX MAP 69, L. 8359, F. 128

NEW MARKET ELECTION DISTRICT NO. 9

**CREEKSIDE HAMPTONS EAST ROUNDABOUT AT GAS HOUSE PIKE AND HIMALAYA ROAD (EAST)** 

**EROSION AND SEDIMENT CONTROL** STAGE 2

DATE: JUNE 2025


SCALE: 1" = 20'

ES-5

A/P #PW277596


DWG. 33 OF 48



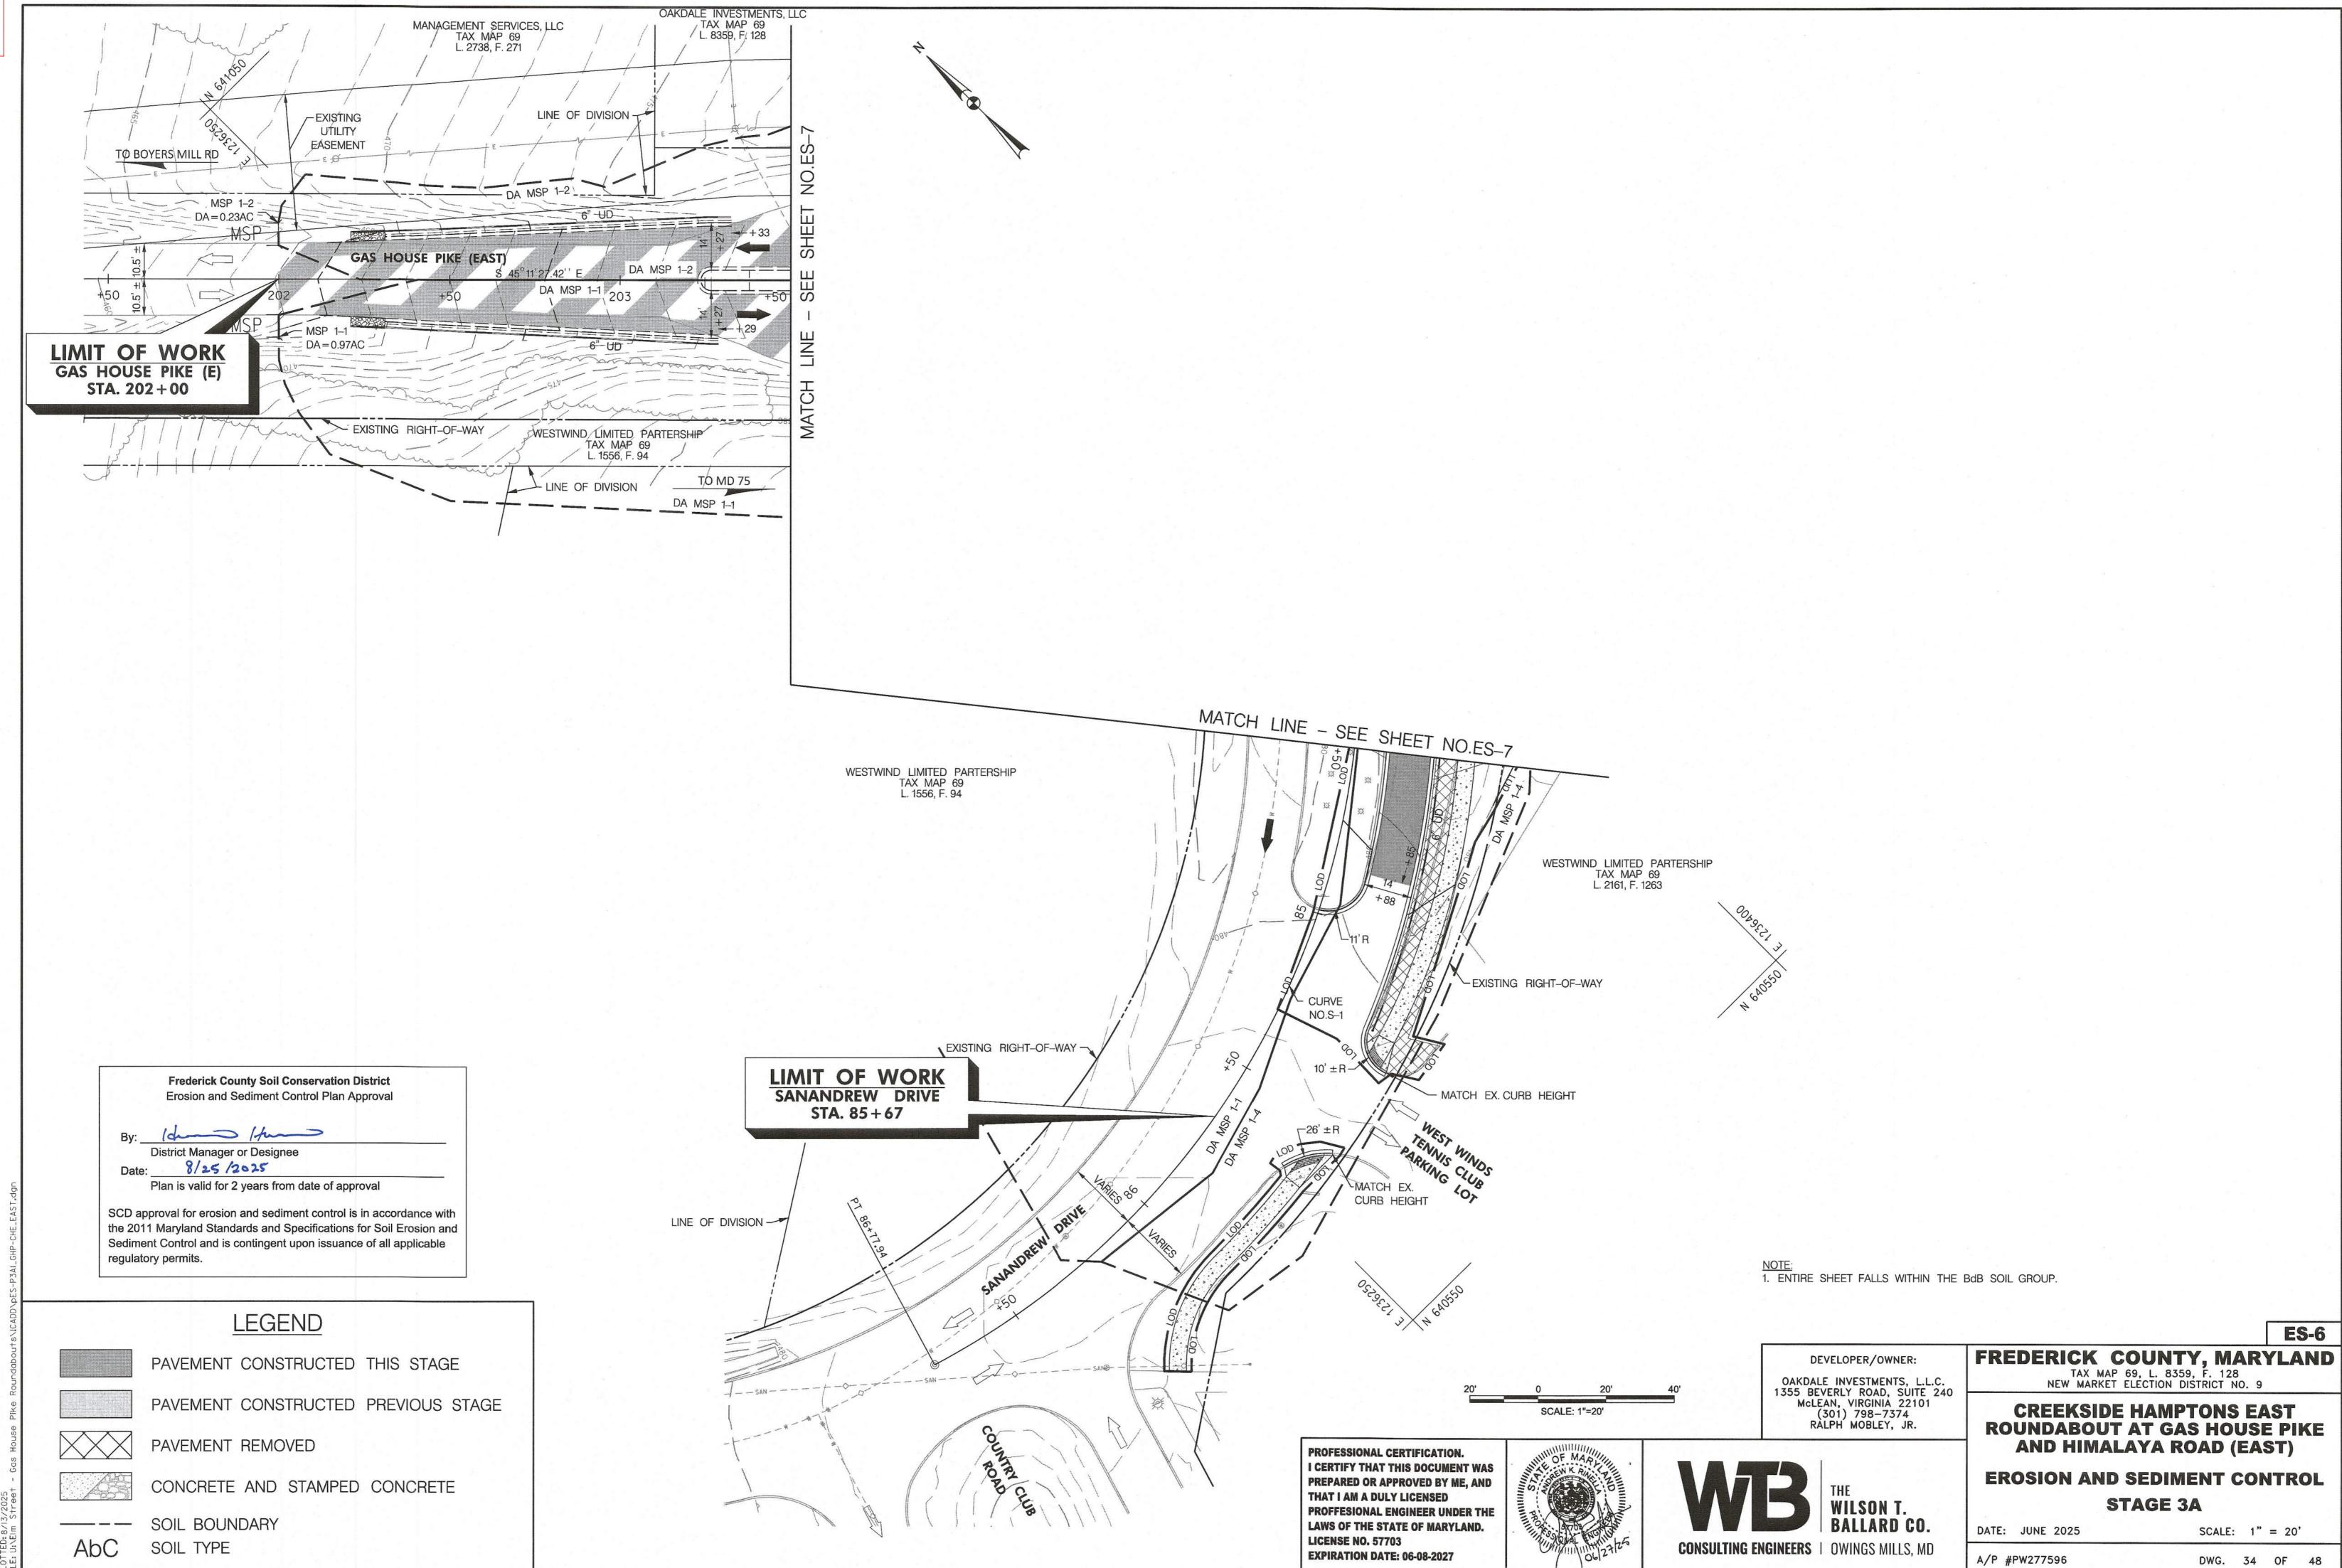



STABILIZED CONSTRUCTION ENTERANCE LOCATION - STATION EA SCE 3-I RT. STA. 205+35

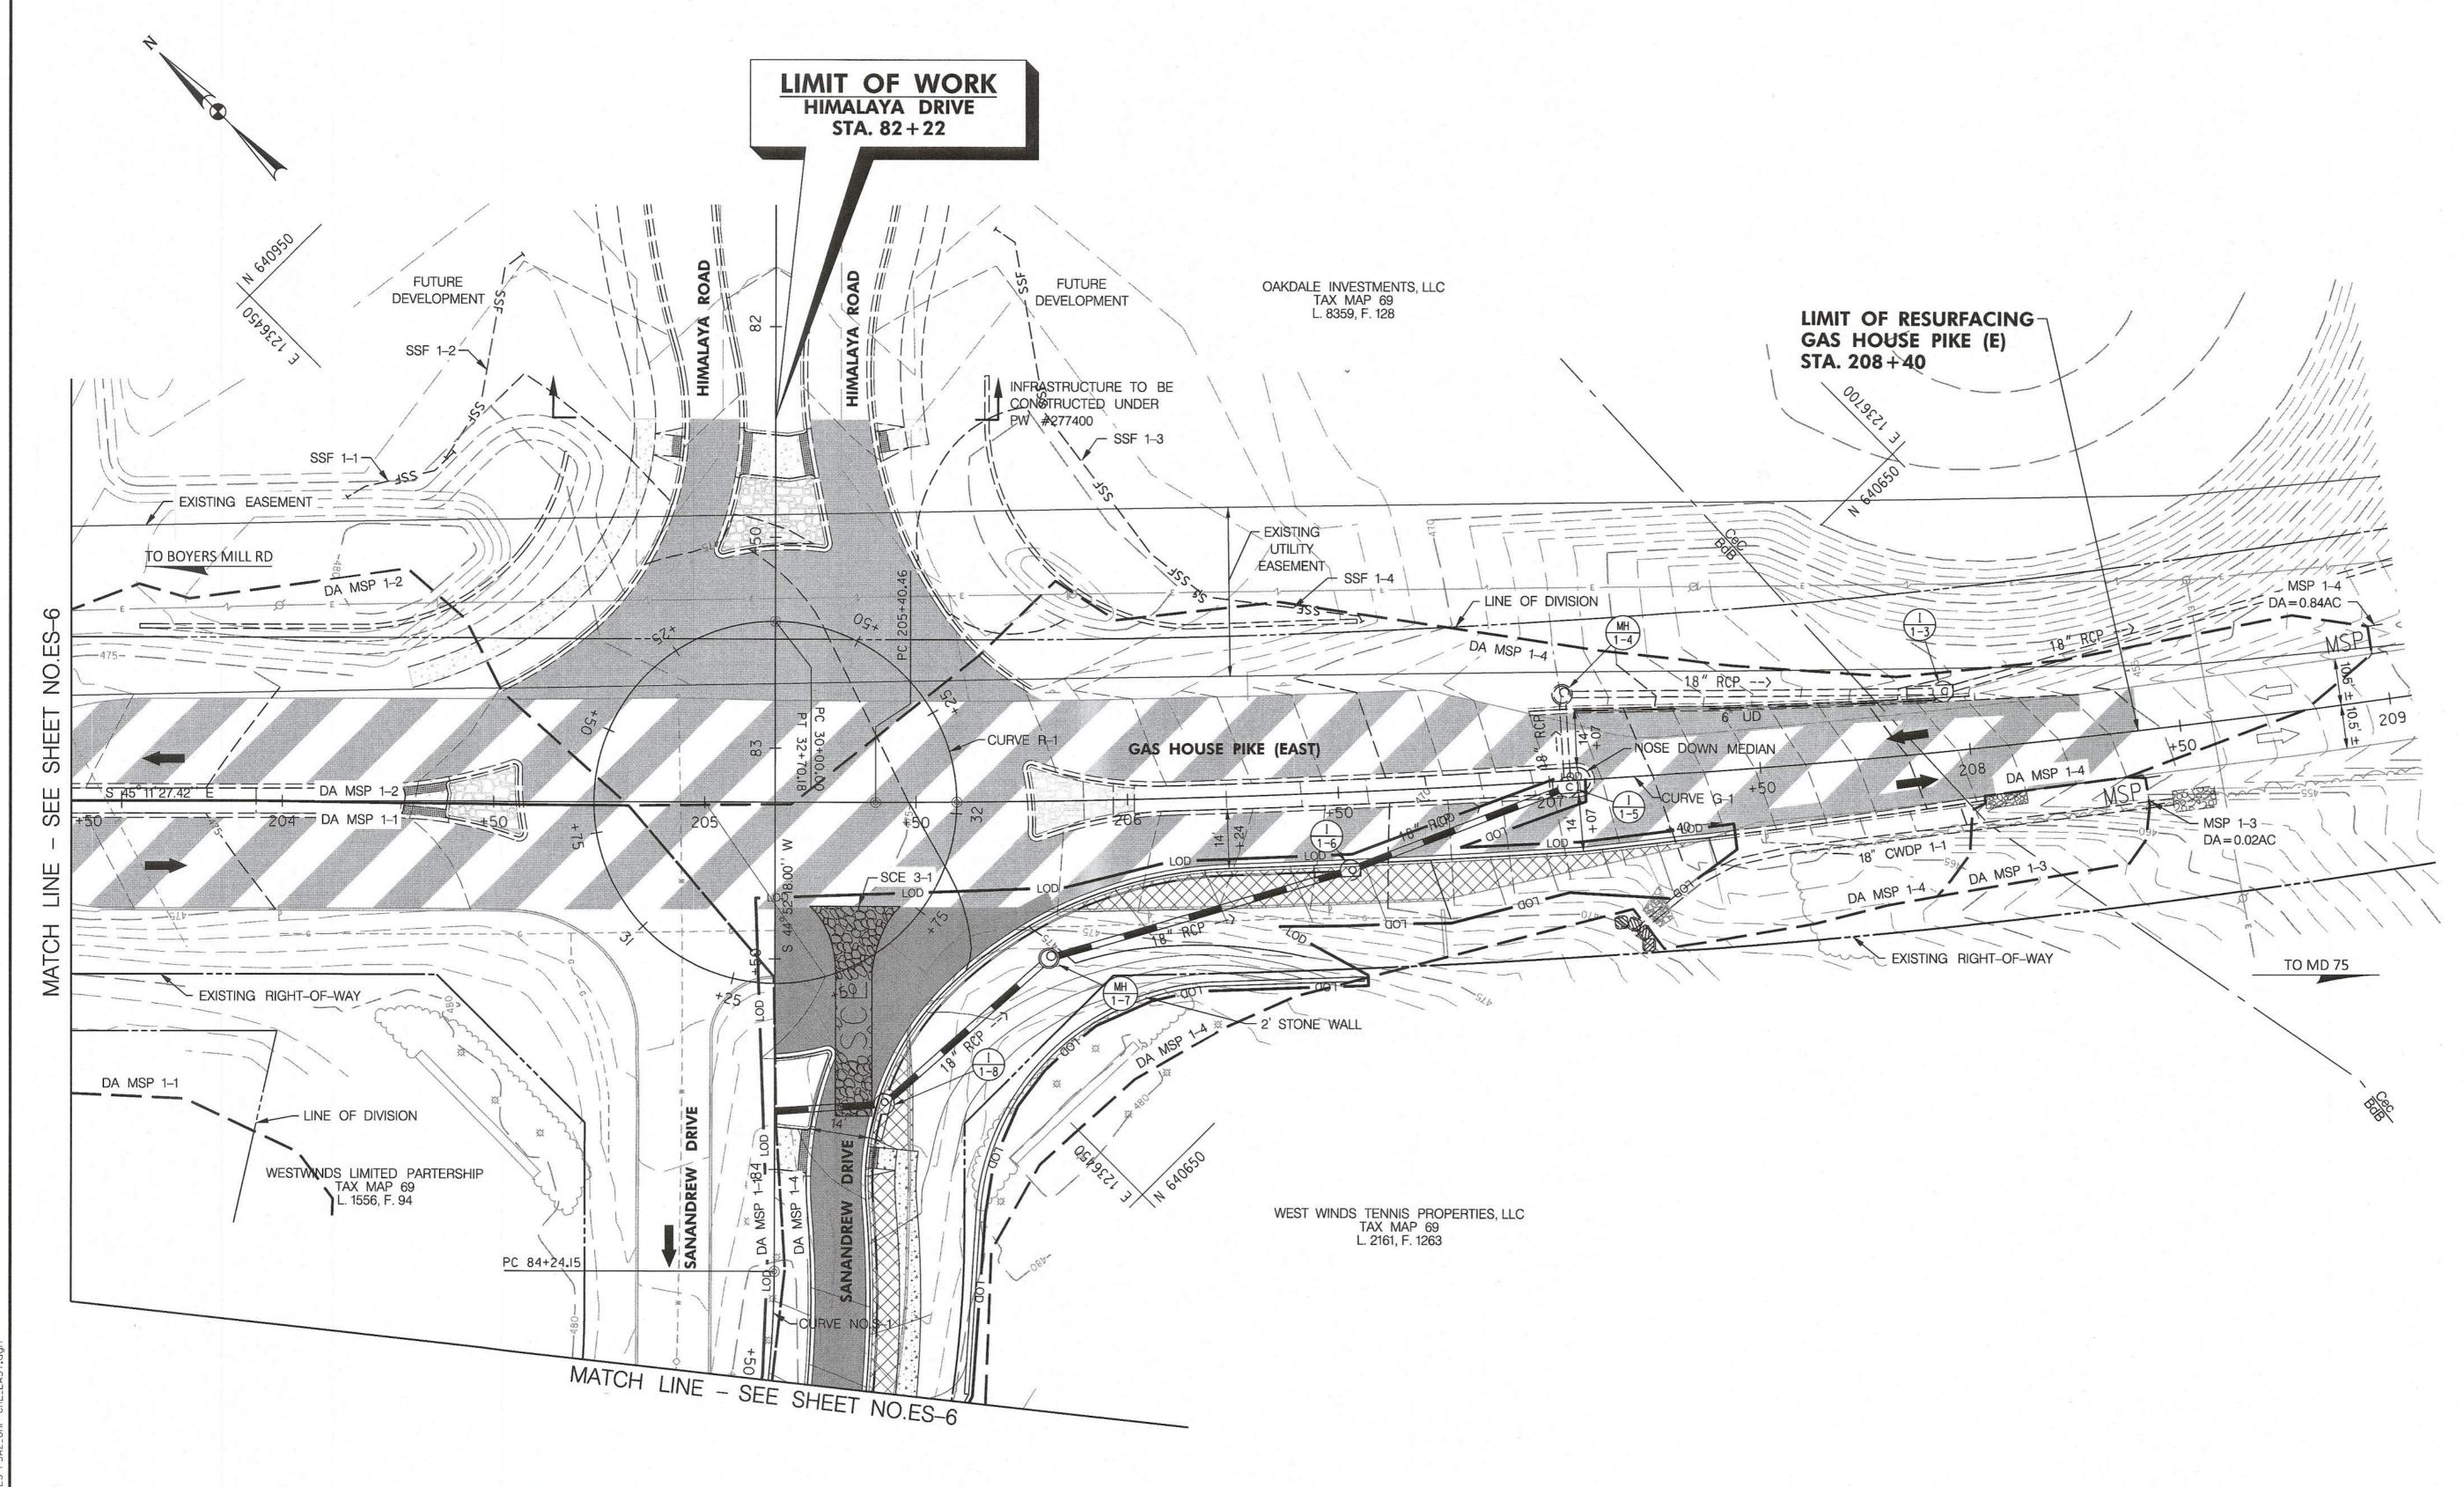

## **LEGEND**

PAVEMENT CONSTRUCTED THIS STAGE

PAVEMENT CONSTRUCTED PREVIOUS STAGE

PAVEMENT REMOVED


CONCRETE AND STAMPED CONCRETE

SOIL BOUNDARY SOIL TYPE

Frederick County Soil Conservation District Erosion and Sediment Control Plan Approval

By: John Hans District Manager or Designee Date: 8/25/2025 Plan is valid for 2 years from date of approval

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PROFESSIONAL CERTIFICATION.

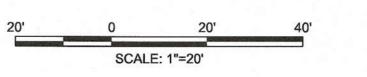THAT I AM A DULY LICENSED

EXPIRATION DATE: 06-08-2027

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DEVELOPER/OWNER: OAKDALE INVESTMENTS, L.L.C. 1355 BEVERLY ROAD, SUITE 240 McLEAN, VIRGINIA 22101 (301) 798-7374 RALPH MOBLEY, JR.

CONSULTING ENGINEERS | OWINGS MILLS, MD

FREDERICK COUNTY, MARYLAND

TAX MAP 69, L. 8359, F. 128

NEW MARKET ELECTION DISTRICT NO. 9

**CREEKSIDE HAMPTONS EAST ROUNDABOUT AT GAS HOUSE PIKE AND HIMALAYA ROAD (EAST)** 

**EROSION AND SEDIMENT CONTROL STAGE 3A** 

DATE: JUNE 2025


SCALE: 1" = 20'

**ES-7** 


A/P #PW277596

DWG. 35 OF 48



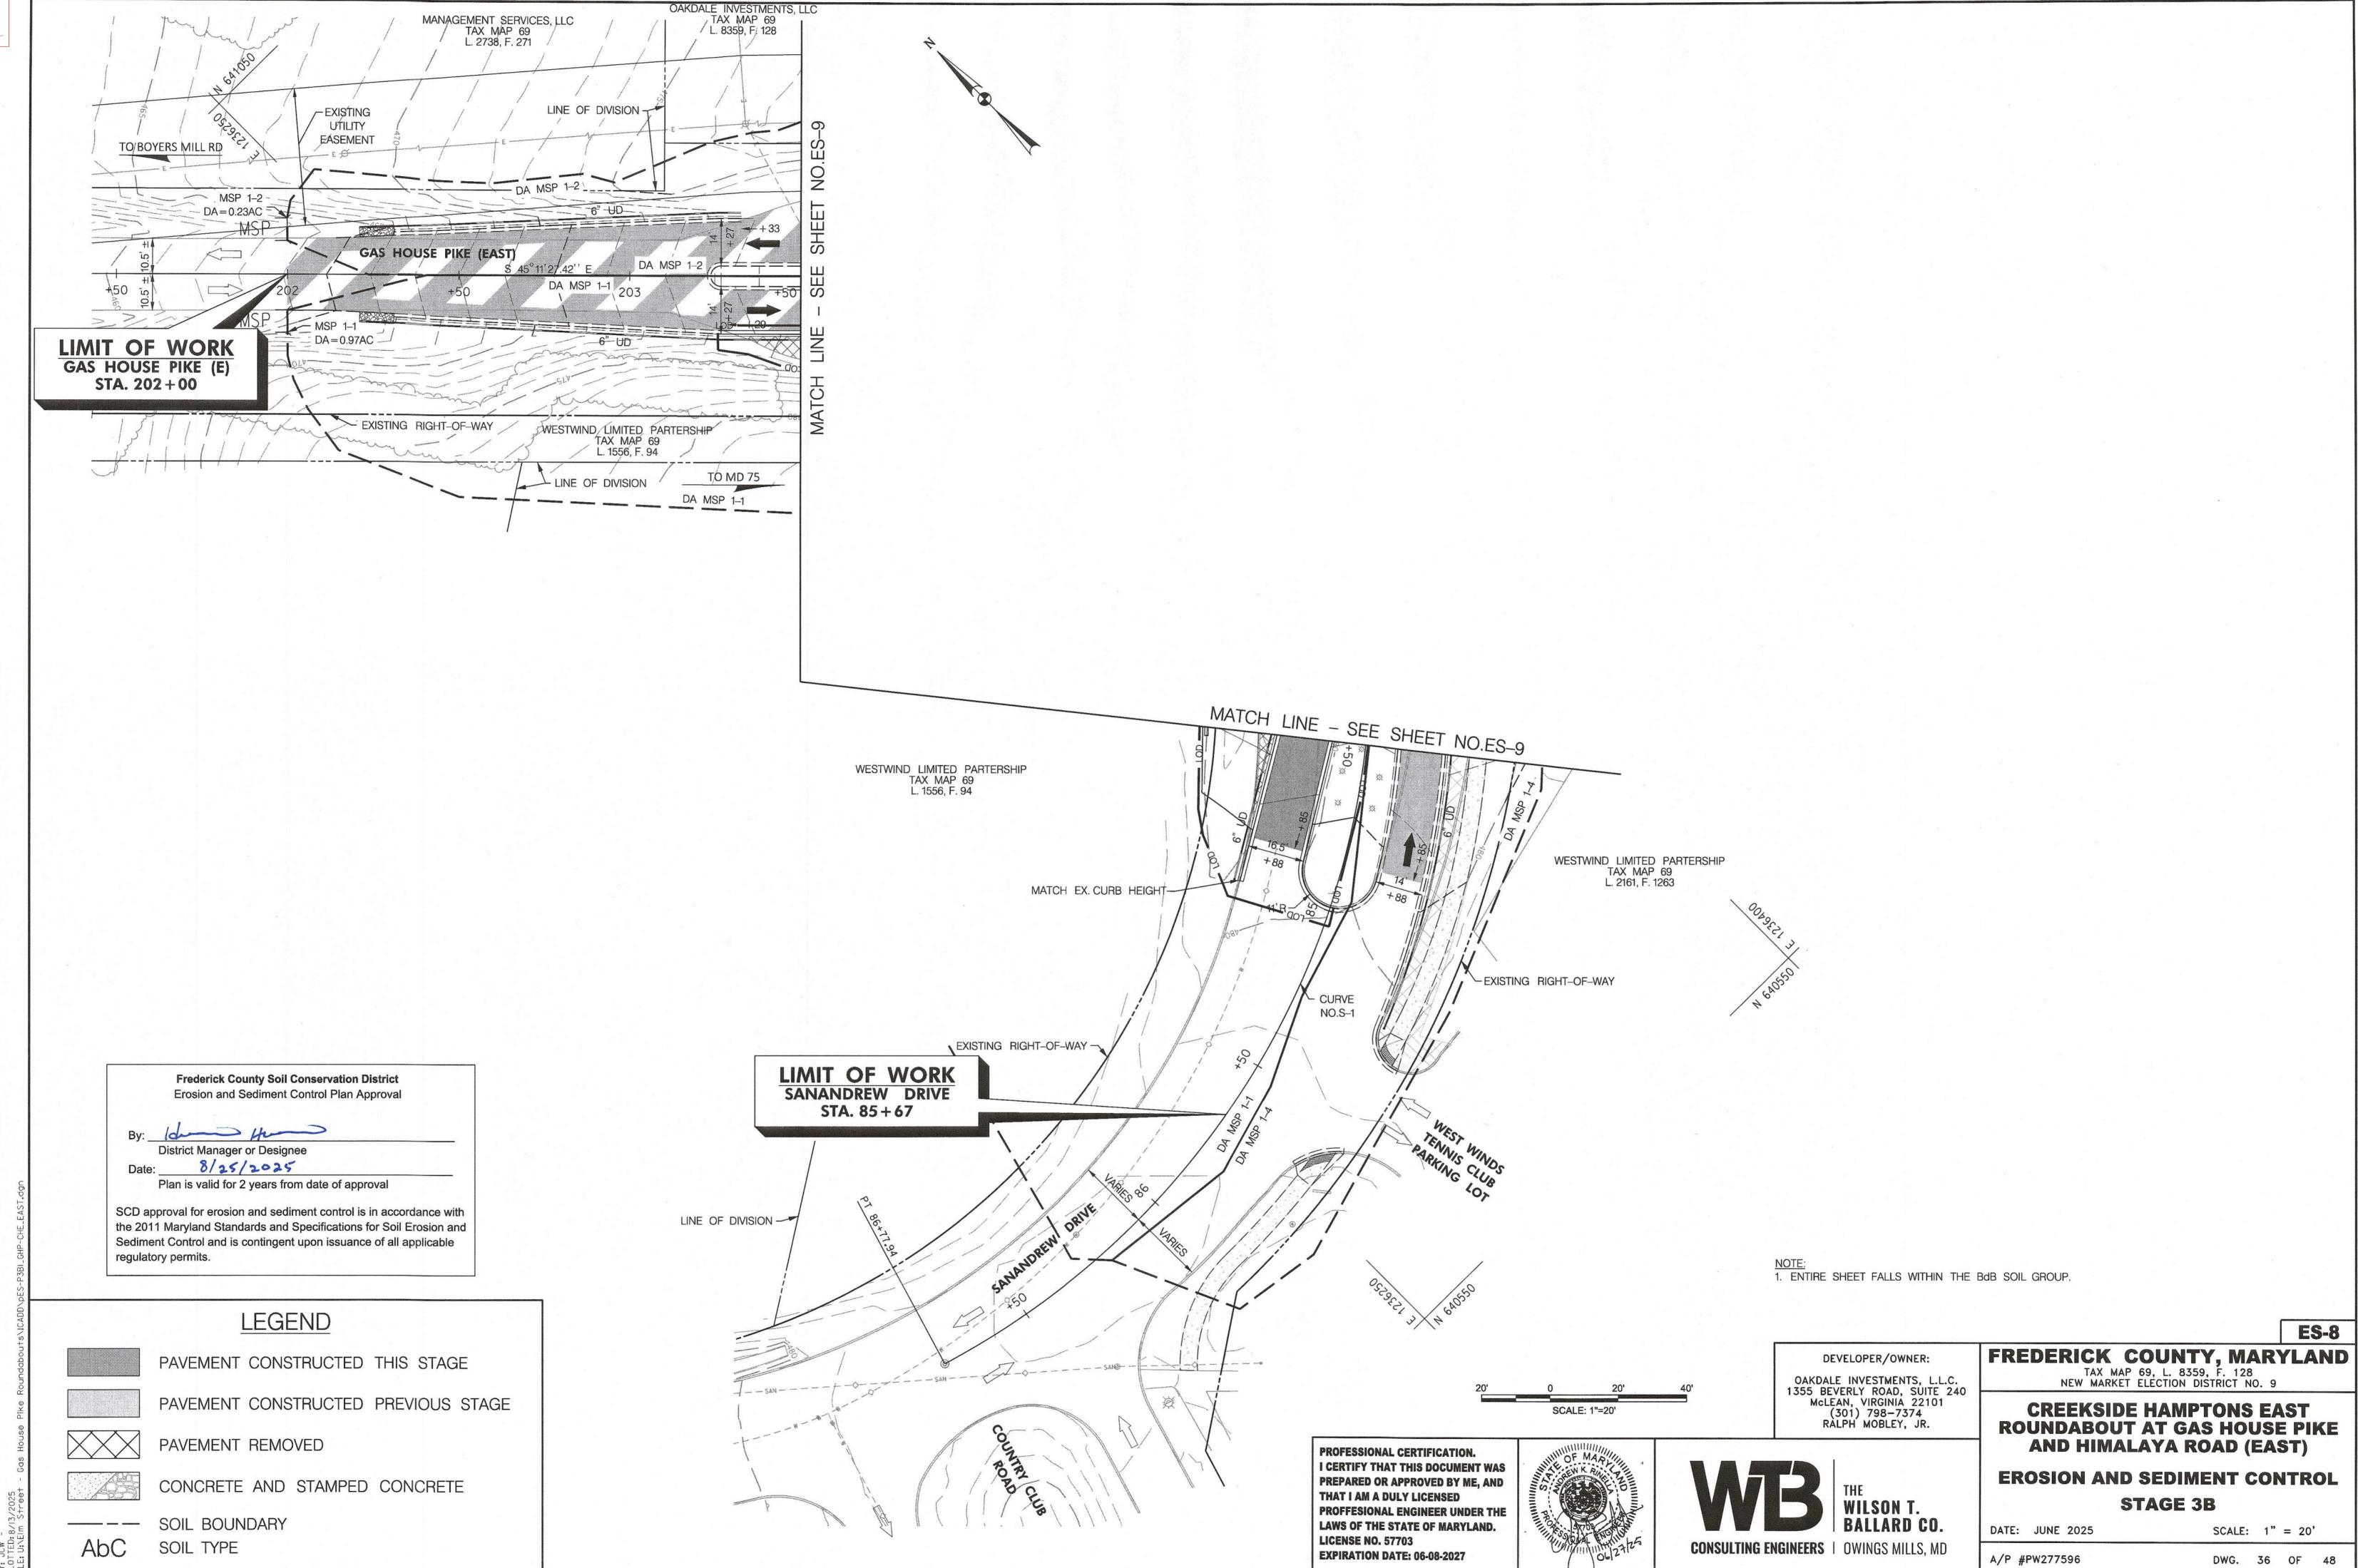



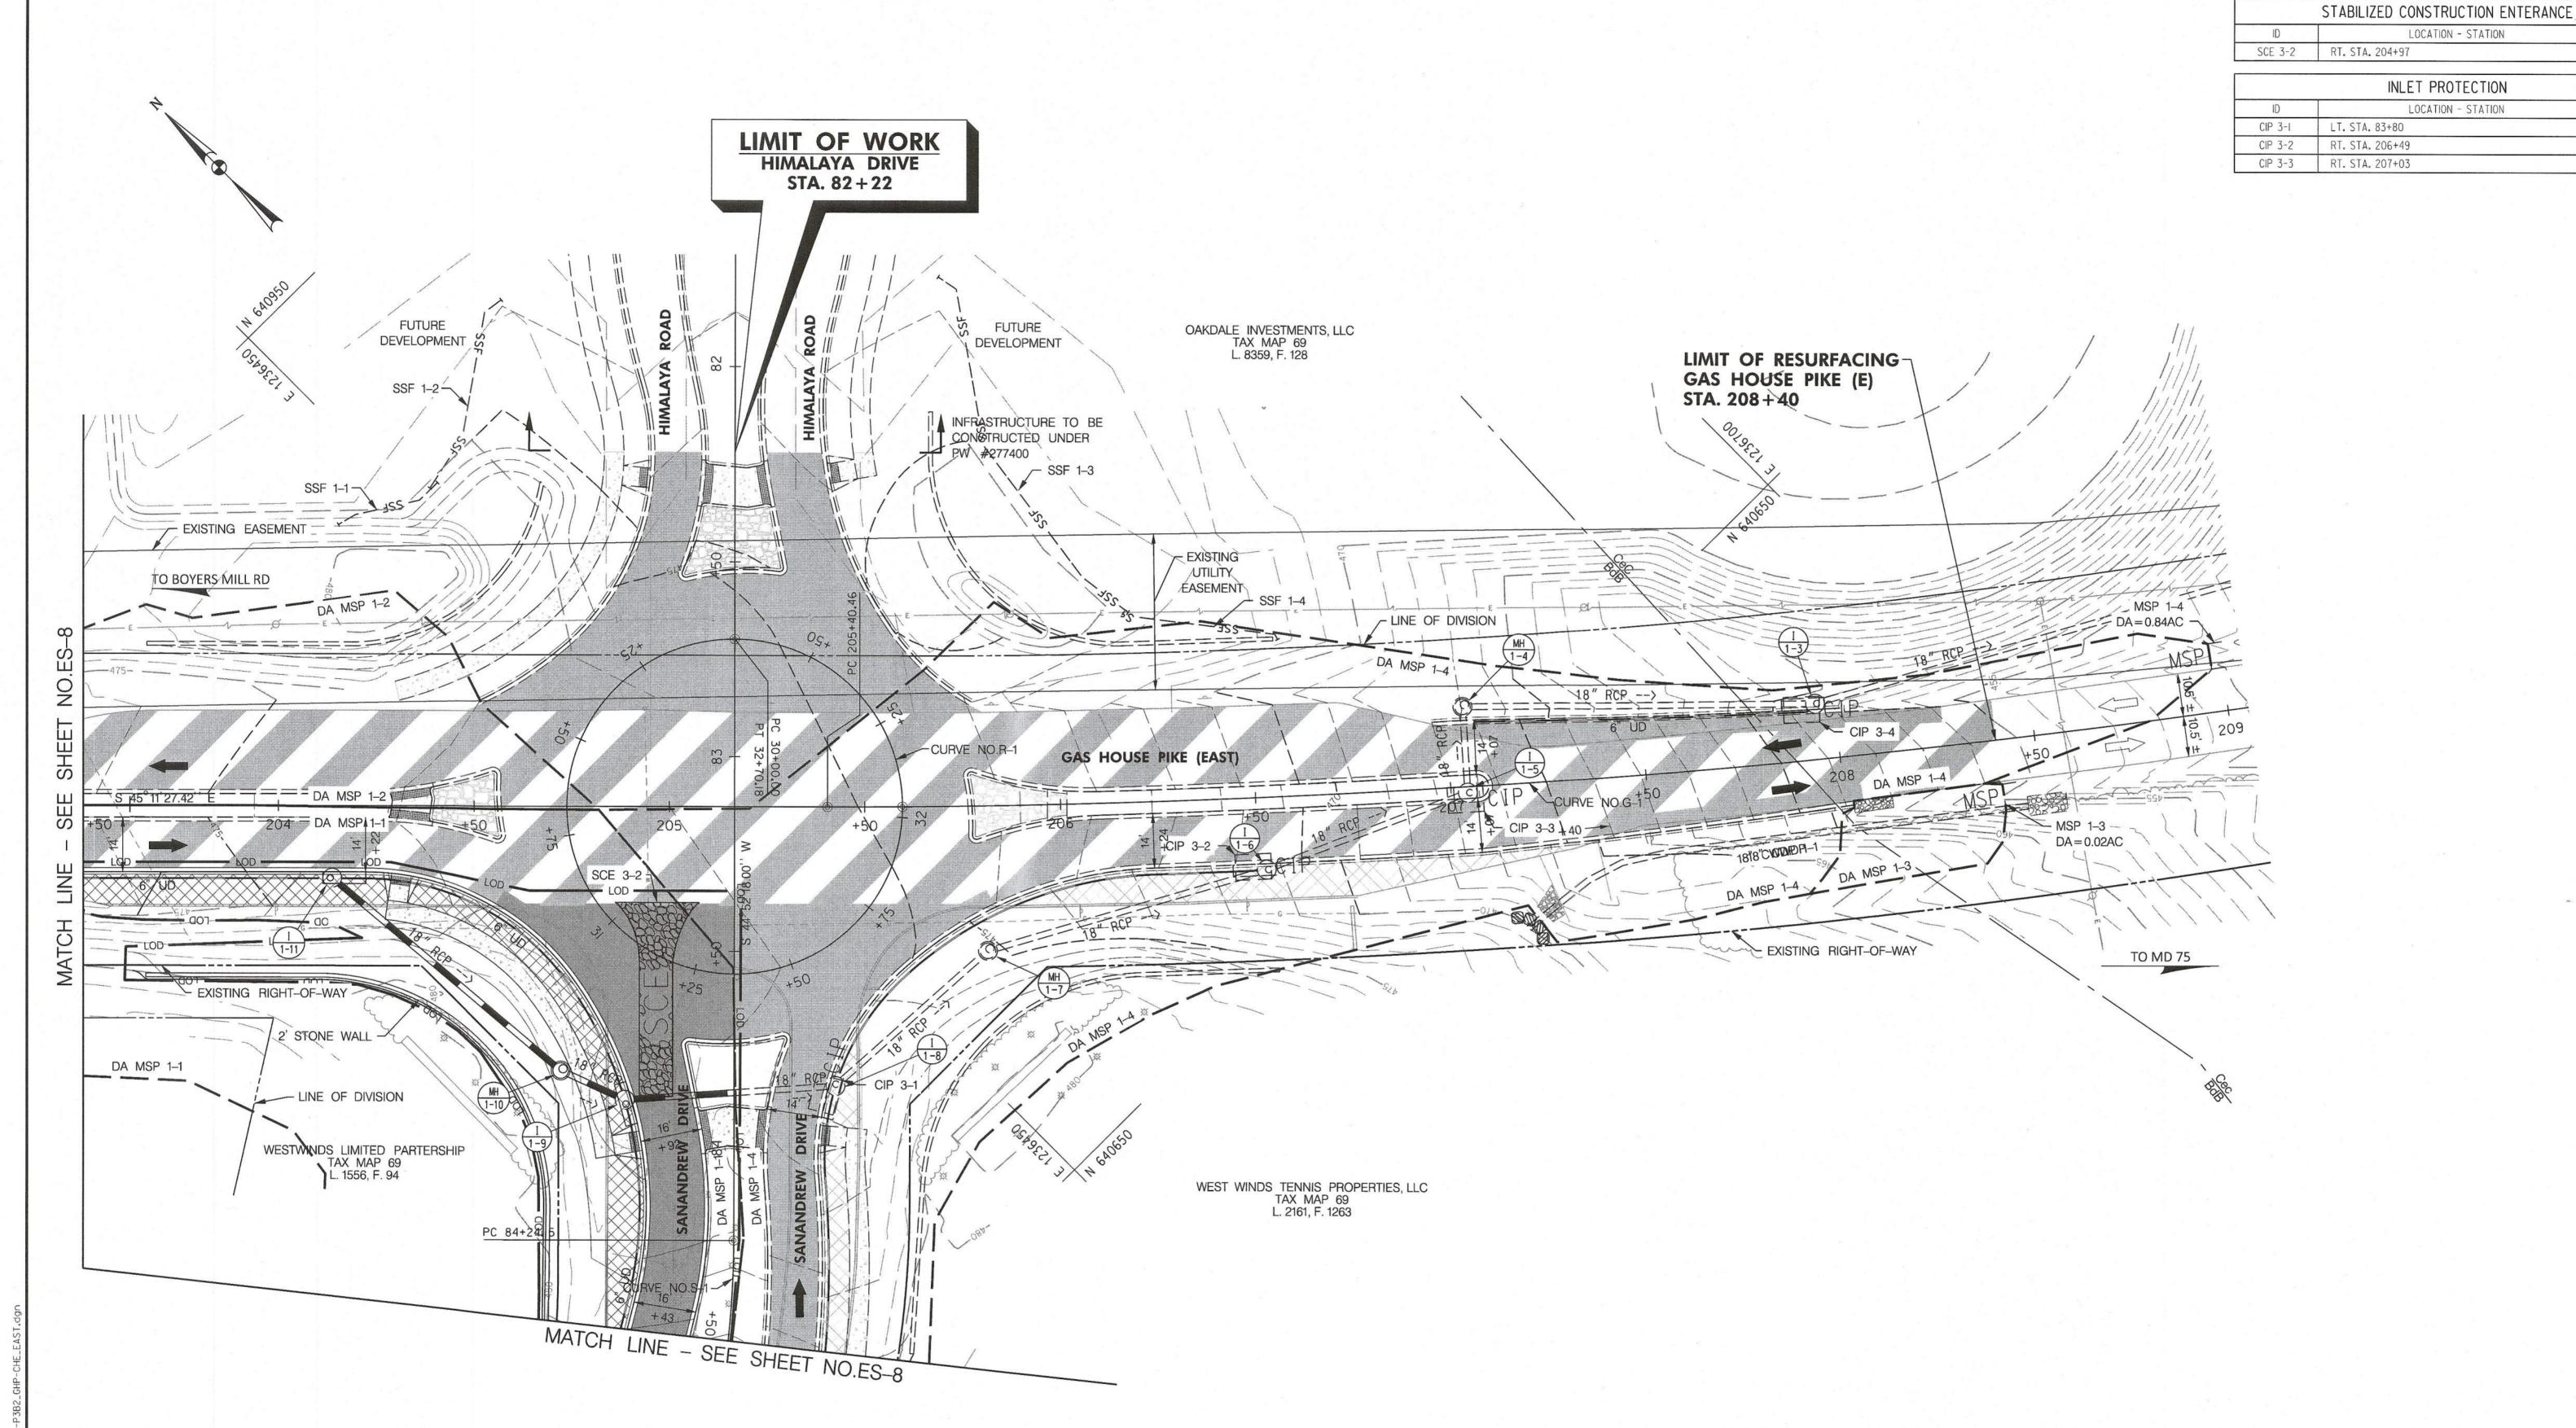






PAVEMENT CONSTRUCTED THIS STAGE

PAVEMENT CONSTRUCTED PREVIOUS STAGE



PAVEMENT REMOVED

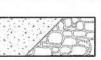


CONCRETE AND STAMPED CONCRETE


**LEGEND** 



SOIL TYPE

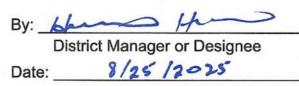

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PROFESSIONAL CERTIFICATION.

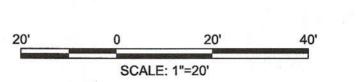THAT I AM A DULY LICENSED

EXPIRATION DATE: 06-08-2027

**LICENSE NO. 57703** 

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DEVELOPER/OWNER:

OAKDALE INVESTMENTS, L.L.C. 1355 BEVERLY ROAD, SUITE 240 McLEAN, VIRGINIA 22101 (301) 798-7374 RALPH MOBLEY, JR.

# FREDERICK COUNTY, MARYLAND TAX MAP 69, L. 8359, F. 128 NEW MARKET ELECTION DISTRICT NO. 9

LOCATION - STATION

LOCATION - STATION

TYPE

CIP

CIP

CIP

INLET PROTECTION

## **CREEKSIDE HAMPTONS EAST ROUNDABOUT AT GAS HOUSE PIKE** AND HIMALAYA ROAD (EAST)

**EROSION AND SEDIMENT CONTROL** STAGE 3B

DATE: JUNE 2025

SCALE: 1" = 20'


**CONSULTING ENGINEERS | OWINGS MILLS, MD** 

A/P #PW277596 DWG. 37 OF 48

Frederick County Soil Conservation District Erosion and Sediment Control Plan Approval

Plan is valid for 2 years from date of approval



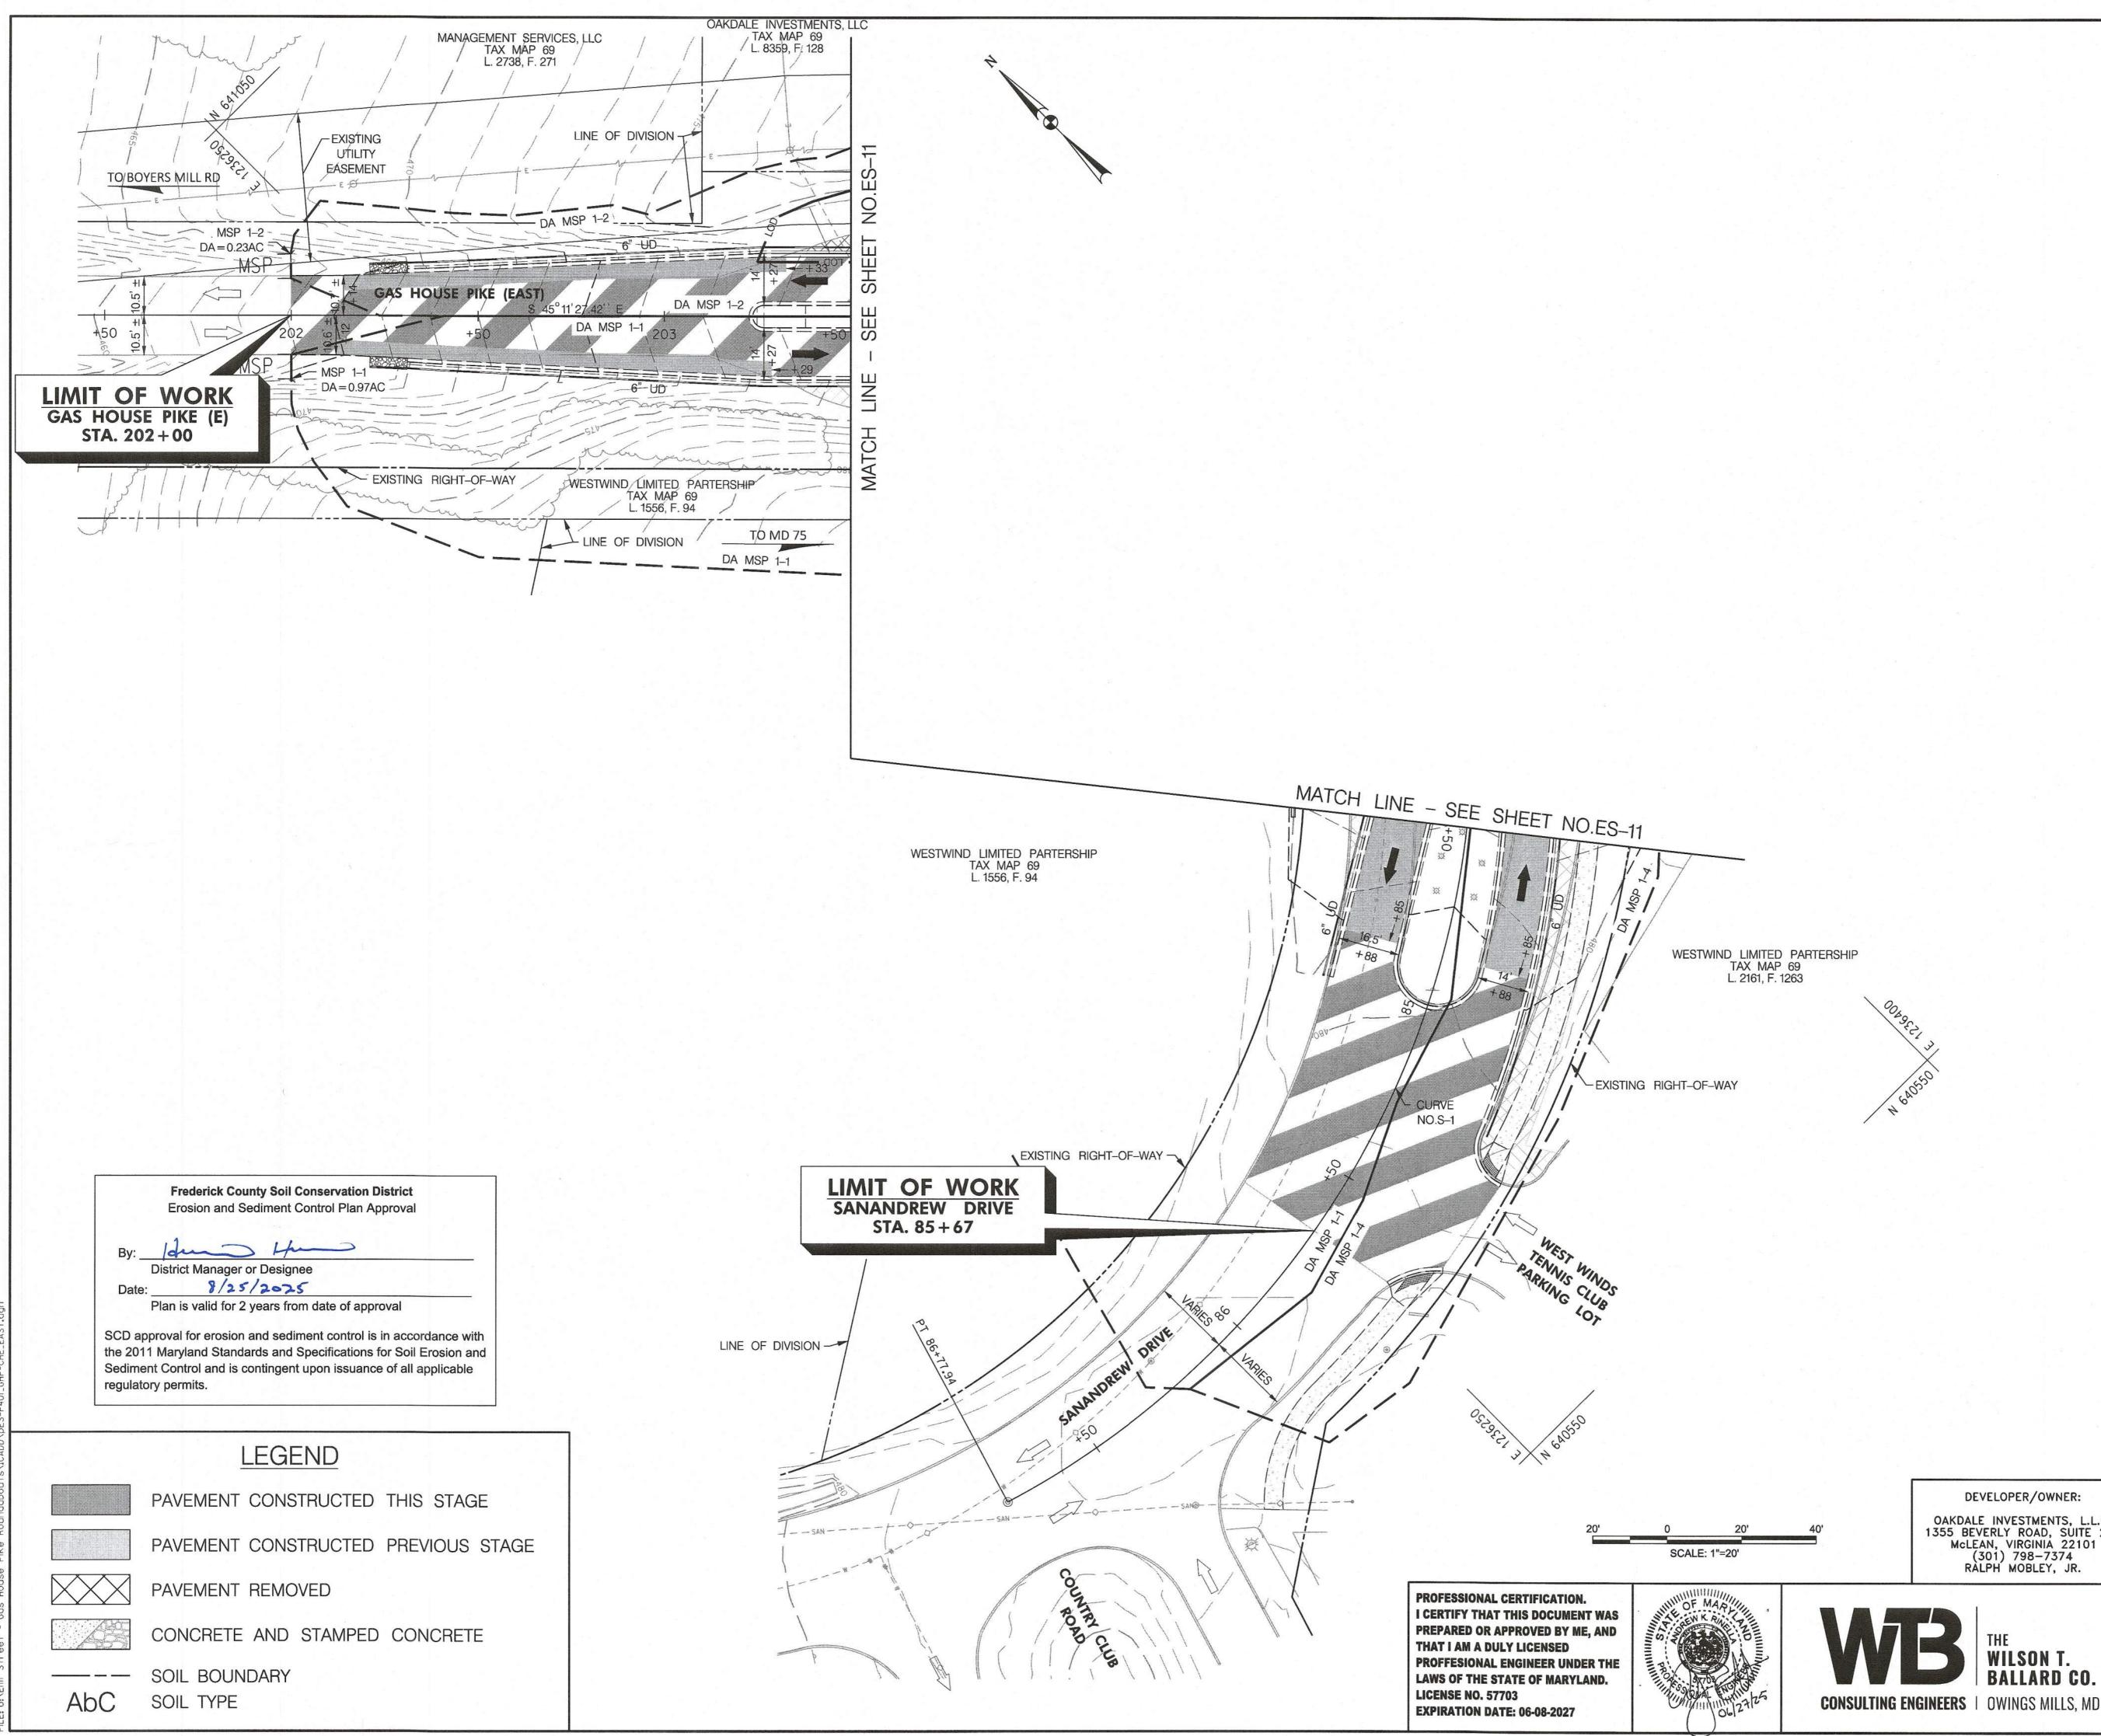

**ES-10** 

FREDERICK COUNTY, MARYLAND

TAX MAP 69, L. 8359, F. 128

NEW MARKET ELECTION DISTRICT NO. 9 OAKDALE INVESTMENTS, L.L.C. 1355 BEVERLY ROAD, SUITE 240 McLEAN, VIRGINIA 22101 (301) 798-7374 RALPH MOBLEY, JR.

**CREEKSIDE HAMPTONS EAST ROUNDABOUT AT GAS HOUSE PIKE AND HIMALAYA ROAD (EAST)** 

**EROSION AND SEDIMENT CONTROL** STAGE 4

DATE: JUNE 2025


SCALE: 1" = 20'

A/P #PW277596

DWG. 38 OF 48



INLET PROTECTION LOCATION - STATION TYPE CIP 4-1 LT. STA. 204+15 CIP RT. STA. 204+15 CIP 4-2 CIP CIP 4-3 RT. STA. 83+92 CIP

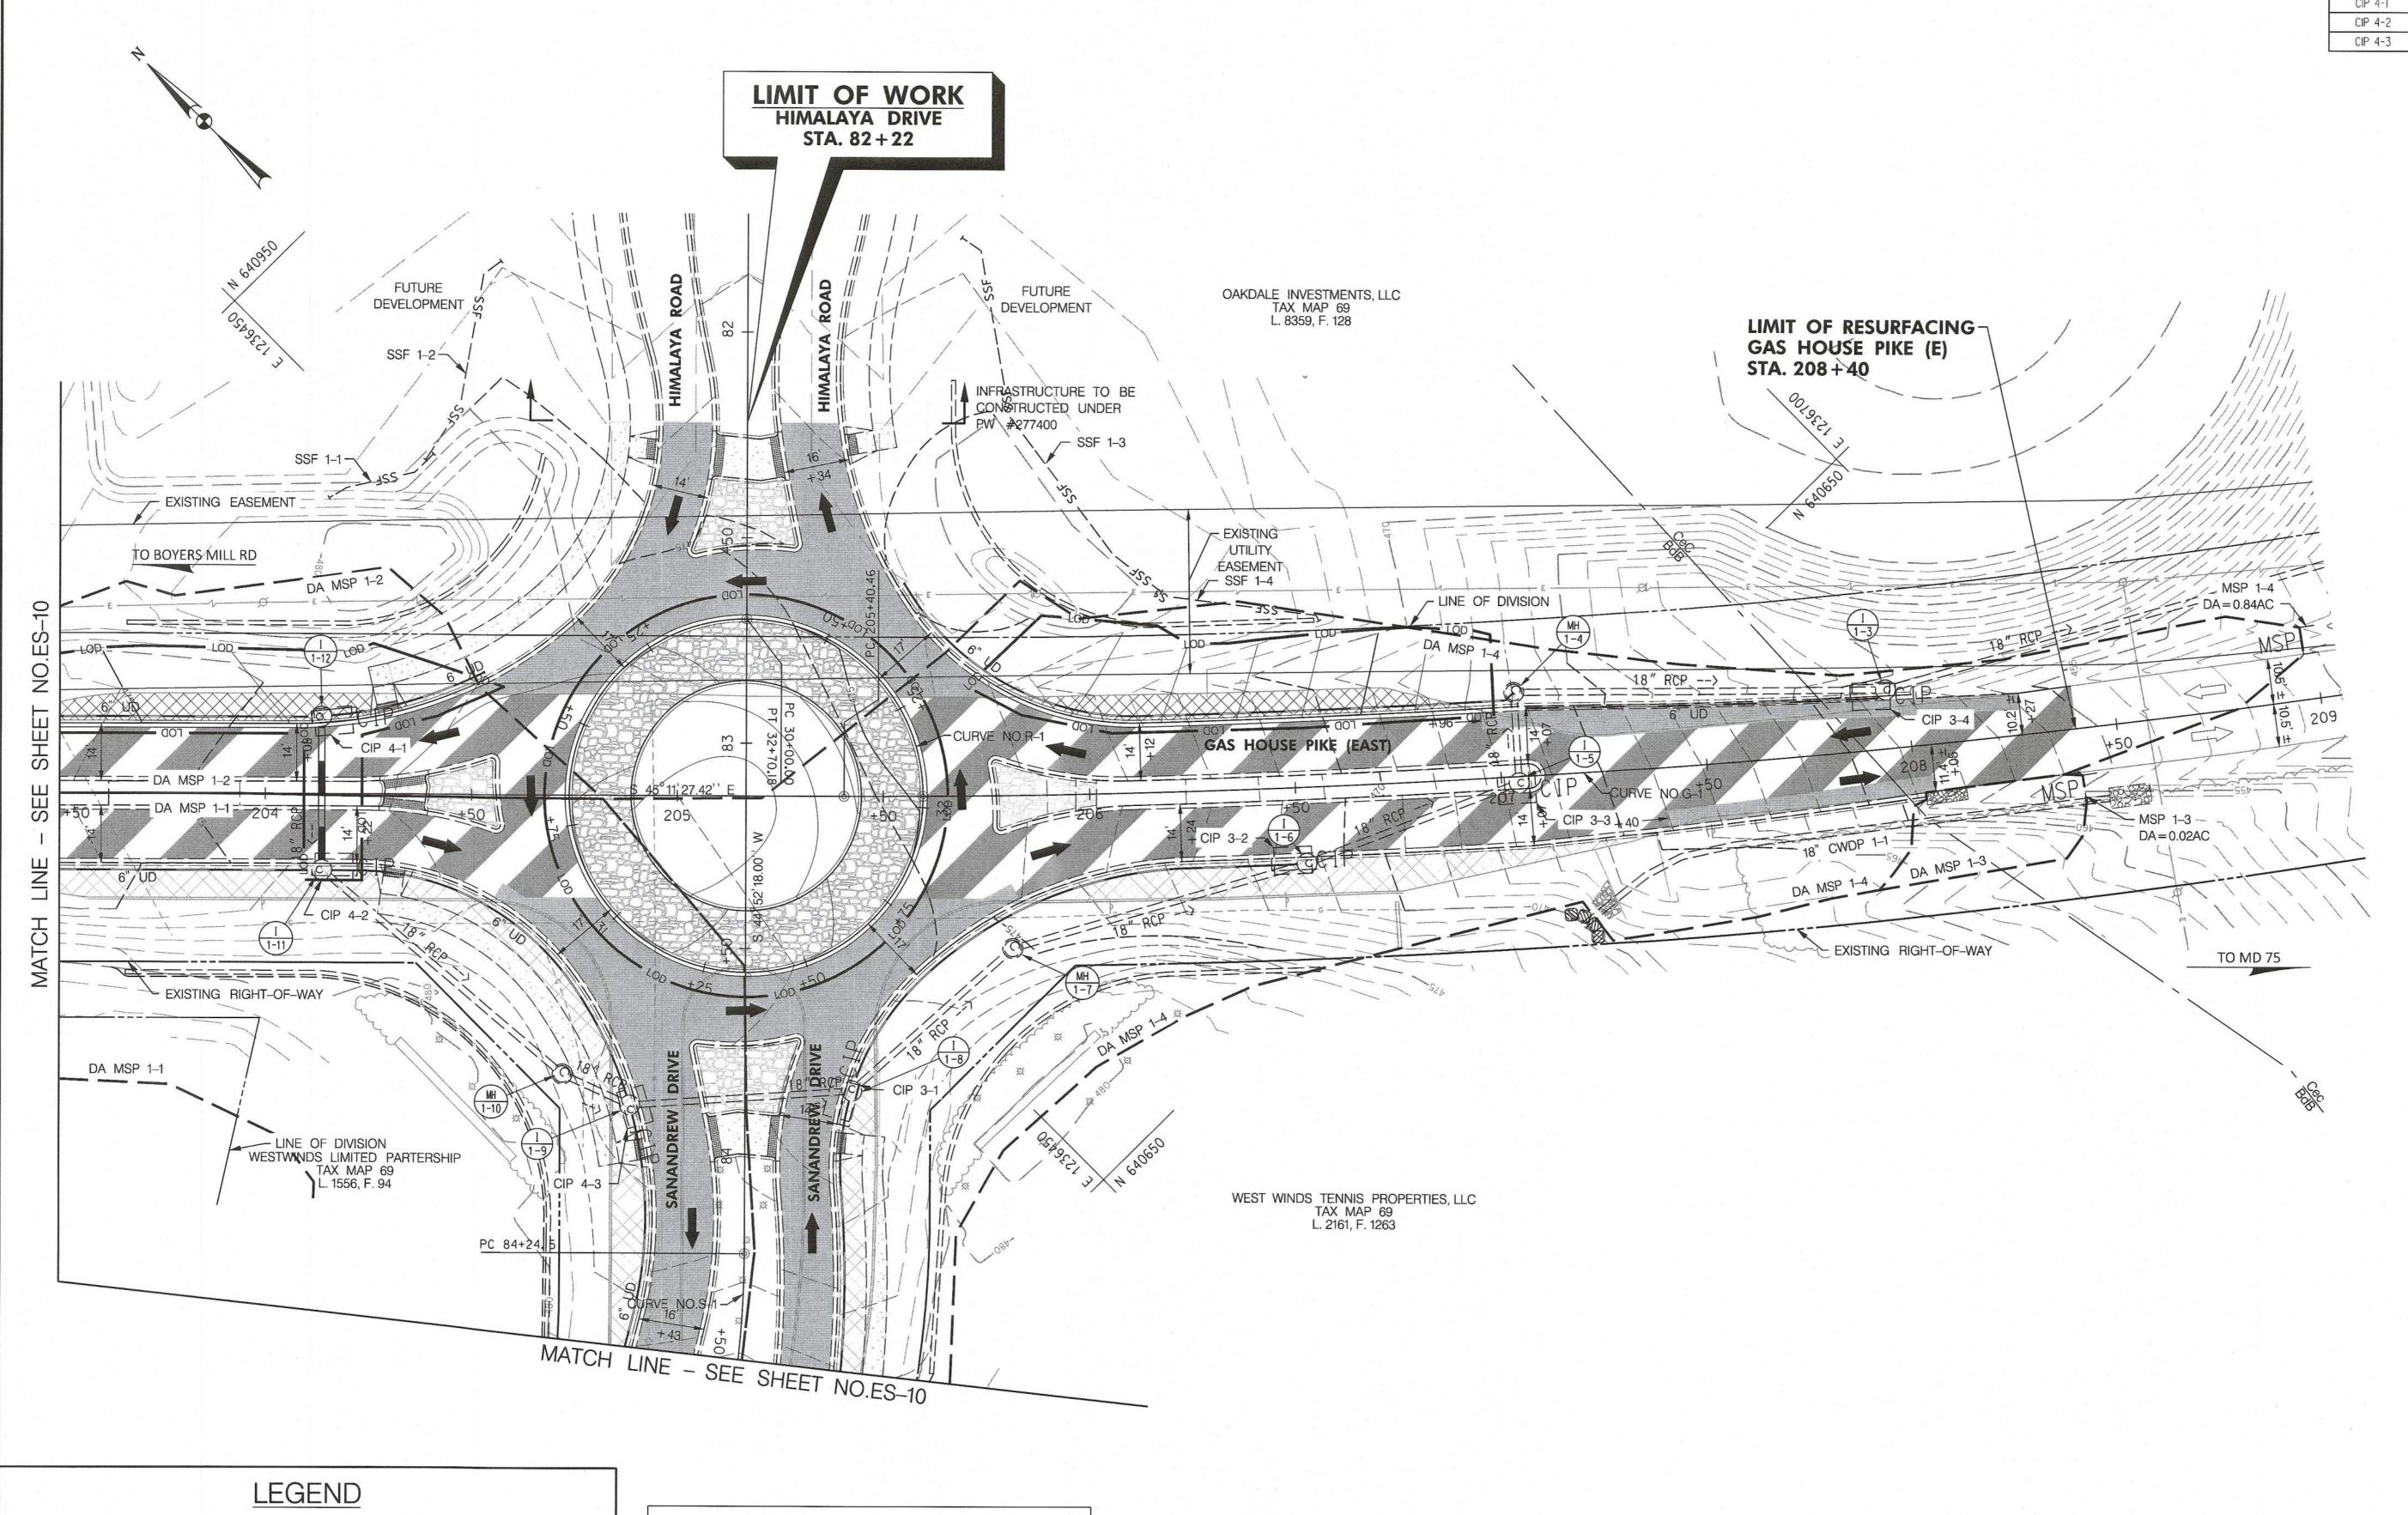

PAVEMENT CONSTRUCTED THIS STAGE

PAVEMENT CONSTRUCTED PREVIOUS STAGE

PAVEMENT REMOVED

CONCRETE AND STAMPED CONCRETE

SOIL BOUNDARY SOIL TYPE

Frederick County Soil Conservation District Erosion and Sediment Control Plan Approval

By: John Ham District Manager or Designee 8/25/2025 Plan is valid for 2 years from date of approval

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DEVELOPER/OWNER: OAKDALE INVESTMENTS, L.L.C. 1355 BEVERLY ROAD, SUITE 240 McLEAN, VIRGINIA 22101 (301) 798-7374 RALPH MOBLEY, JR.

**CONSULTING ENGINEERS** | OWINGS MILLS, MD

## **ES-11** FREDERICK COUNTY, MARYLAND TAX MAP 69, L. 8359, F. 128 NEW MARKET ELECTION DISTRICT NO. 9

**CREEKSIDE HAMPTONS EAST** 

**ROUNDABOUT AT GAS HOUSE PIKE** AND HIMALAYA ROAD (EAST)

**EROSION AND SEDIMENT CONTROL** STAGE 4

DATE: JUNE 2025

SCALE: 1" = 20'

A/P #PW277596 DWG. 39 OF 48